



VINCIULLO WAY

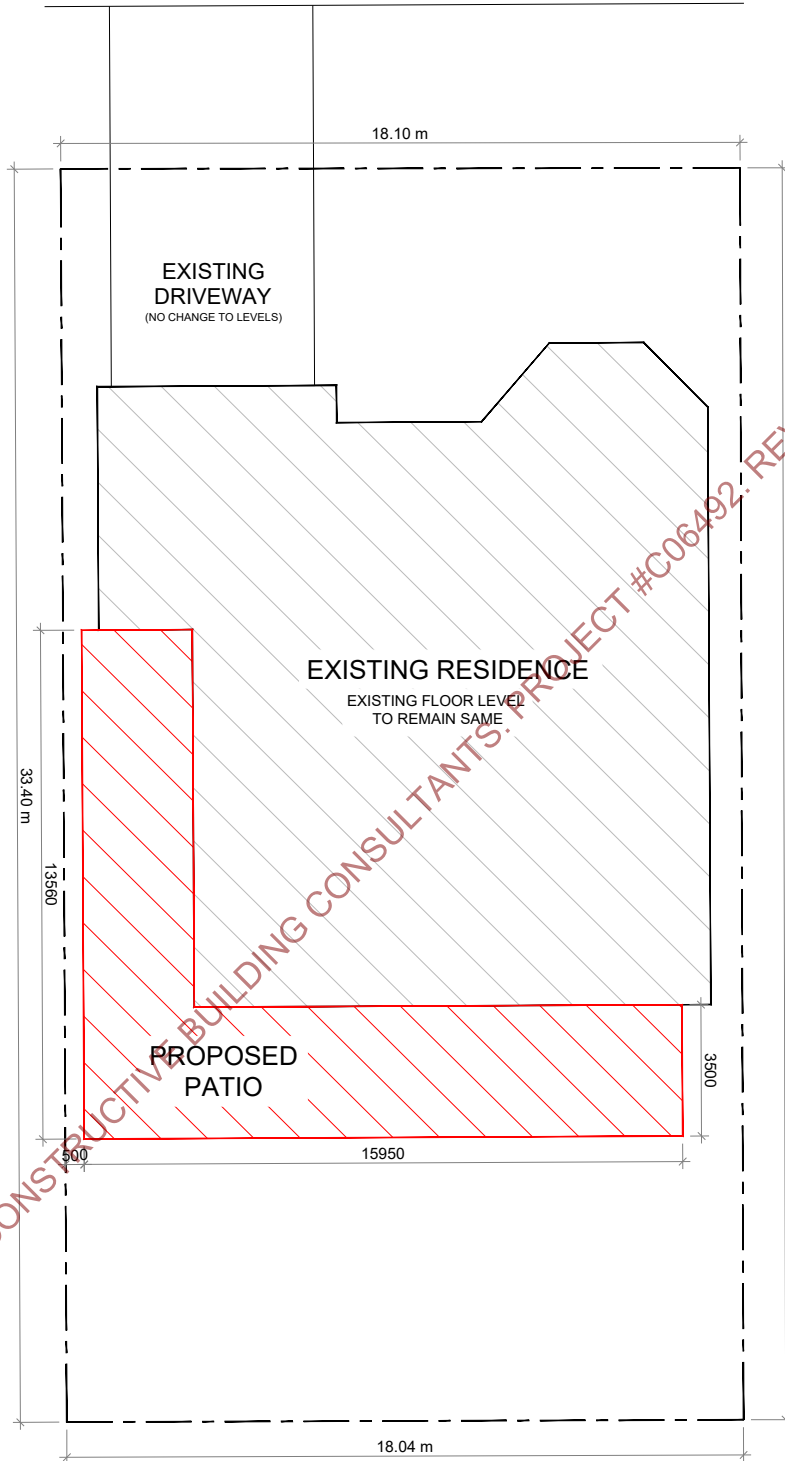


CERTIFIED BY CONSTRUCTIVE BUILDING CONSULTANTS PROJECT #C06492 REV 0.21/06/2023


SITE PLAN

SCALE 1:200

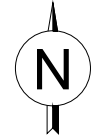


- CLASS 10A COMPLIANCE NOTES**
1. All storm water to be contained on site.
 2. Ground levels to remain unaltered.
 3. Where applicable, the BAL construction requirements applicable to the existing dwelling are to be applied to the proposed patio/carport/shed.
 4. Steps must be taken to ensure that existing structures on adjoining properties are not undermined.
 5. Concrete must comply with AS 3600.
 6. Metal sheet roofing shall adhere with AS 1562.1, and where necessary be protected from corrosion.
 7. Plastic sheet roofing shall adhere with AS 1562.3.

	PROJECT NAME:	PATIO ADDITION
	ADDRESS:	10 VINCIULLO
JOB NO:	-	SCALE: AS SHOWN
DRAWN BY:	PG	SHEET: 1 OF 2

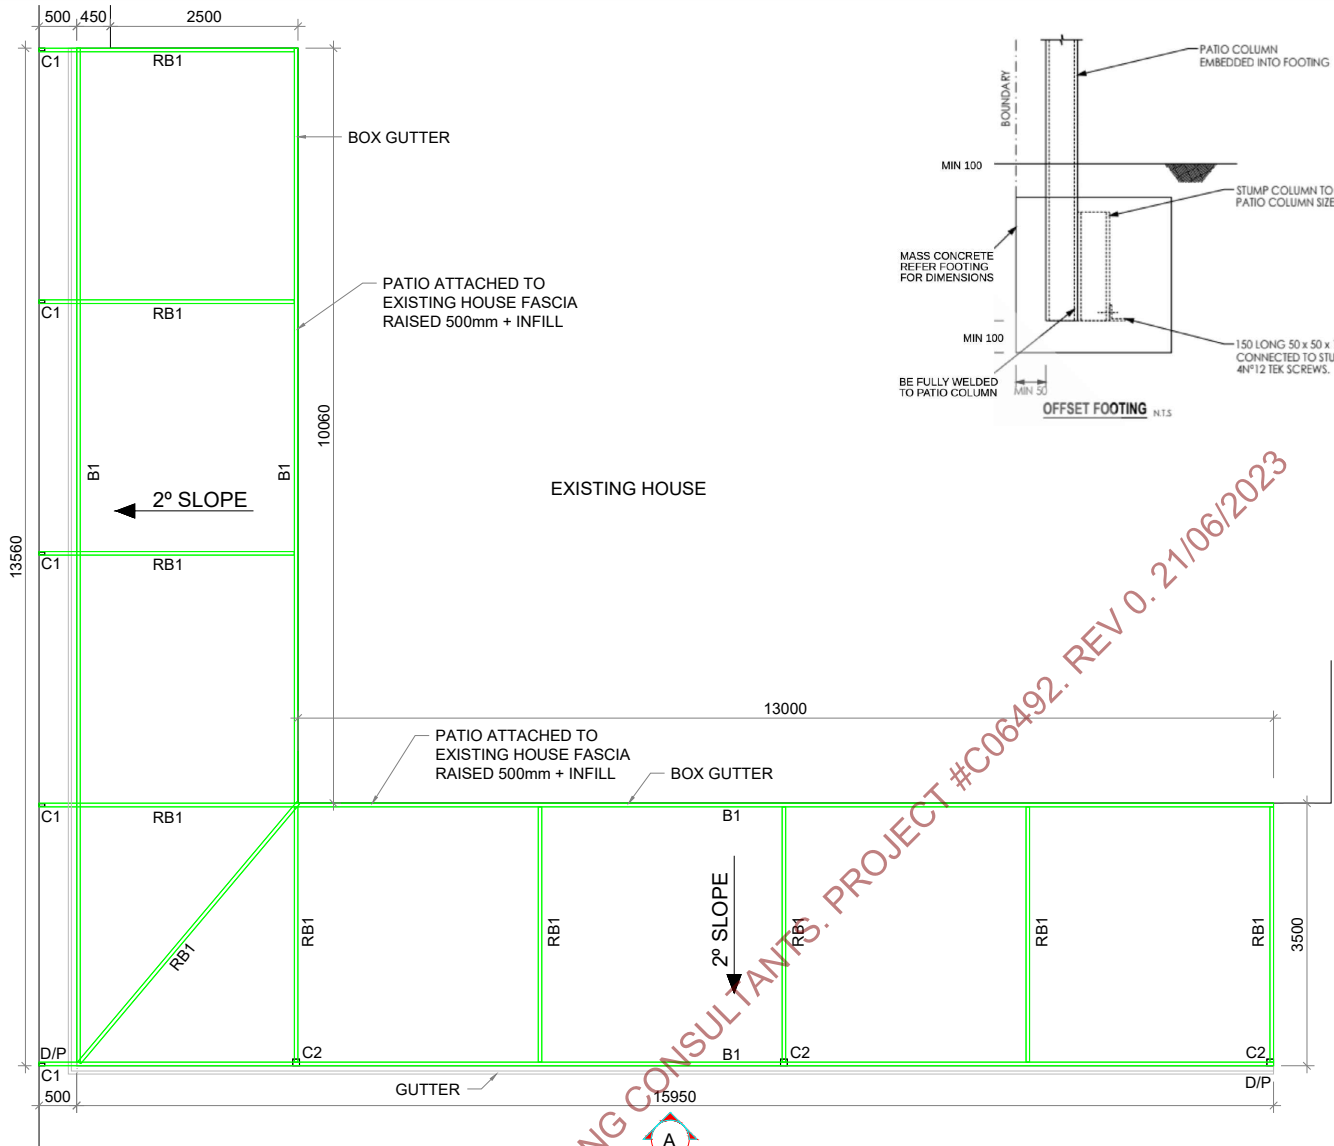

PROPOSED PATIO PLAN

SCALE 15950 1:100

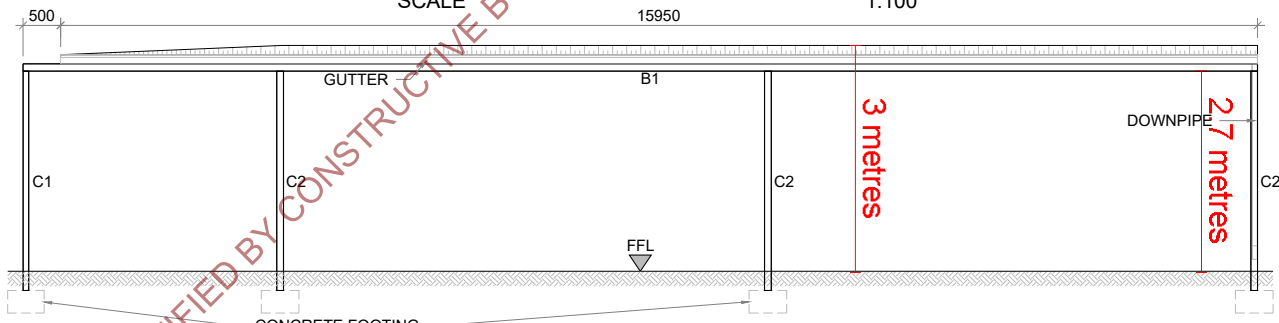


ELEVATION - A

SCALE 15950 1:100

FFL - FINISH FLOOR LEVEL (GROUND)
 *NOTE: NO CHANGE TO EXISTING FLOOR LEVELS

SCHEDULE OF STRUCTURAL FRAMING	
BEAM/ COLUMN TAG NO	SIZE
C1	SHS 76x38mm
C2	SHS 90x90mm
B1	TO ENG. DETAIL
RB1	

- CLASS 10A COMPLIANCE NOTES**
- All storm water to be contained on site.
 - Ground levels to remain unaltered.
 - Where applicable, the BAL construction requirements applicable to the existing dwelling are to be applied to the proposed patio/carpport/shed.
 - Steps must be taken to ensure that existing structures on adjoining properties are not undermined.
 - Concrete must comply with AS 3600
 - Metal sheet roofing shall adhere with AS 1562.1, and where necessary be protected from corrosion.
 - Plastic sheet roofing shall adhere with AS 1562.3.

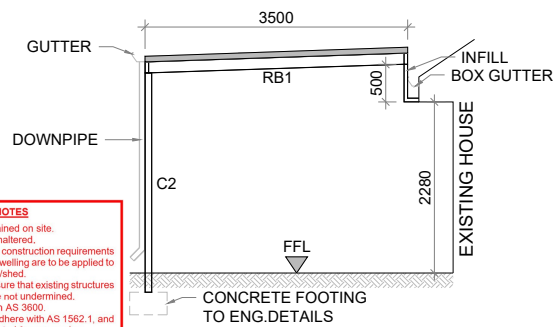

ELEVATION - B

SCALE 3500 1:100

	PROJECT NAME: PATIO ADDITION
	ADDRESS: 10 VINCIULLO
JOB NO: -	SCALE: AS SHOWN
DRAWN BY: PG	SHEET: 2 OF 2