SITE ZONING TOTAL AREA OF SITE AREA OF BUILDING	R20 636.00m ² 338.42m ²
SITE COVERAGE	53.21%
ALLOWABLE COVERAGE	50.00%

Prelay

All plumbing, electrical, stormwater and irrigation conduits to be installed prior to pouring concrete or laying paving

Paving

Extent of paving shown indicative only; Paving to be confirmed prior to commencement of works

Iermite treatment

Supply and install Termite management system as per BCA clause 3.14 and to comply with AS 3660.1-2014 & manufacturers specification

Letterbox


maximum height of letterbox 750mm rendered brick finish to match house elevation

Significant Tree



Stormwater


Soakwell location shown as a guide only & to be confirmed by contractor prior to commencement. Refer to floor plans for downpipe locations and ensure all downpipes are connected to soakwells

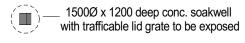


1500Ø x 1200 deep conc.

soakwell

Stormwater Calculation

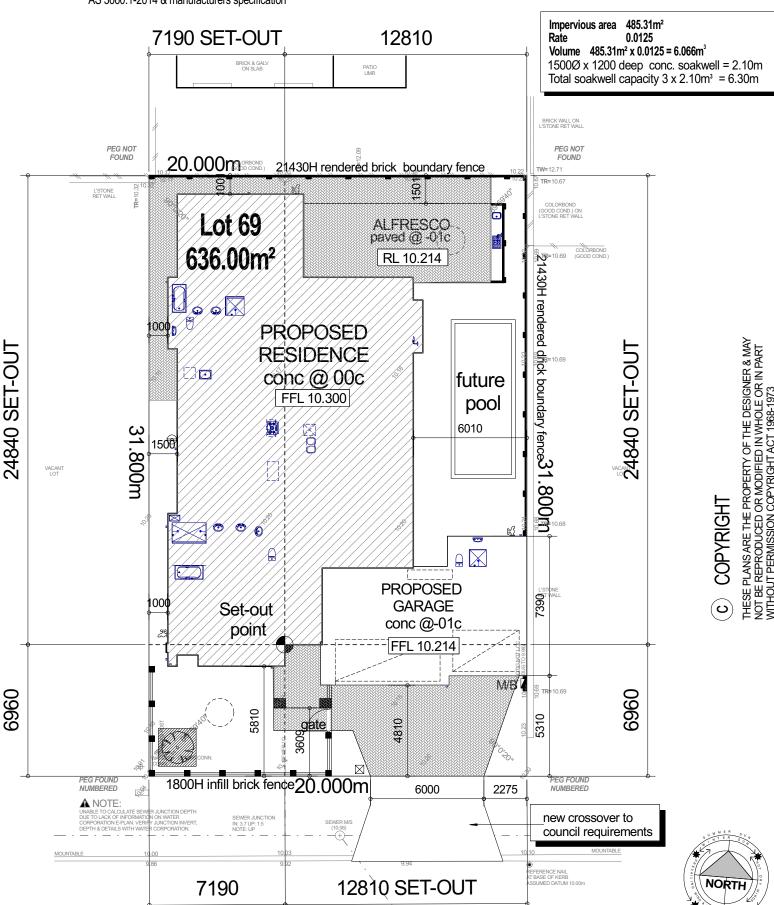

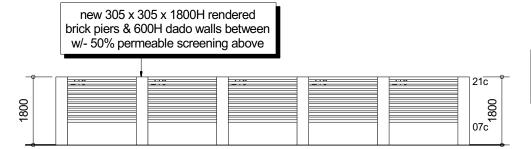

Typical Front Fence Elevation

BAL RATING 12.5

CONSTRUCTION TO COMPLY WITH AS 3959-2018

Site Plan Scale 1:200 @ A3

scale 1:100 @ A3 REV. DATE: DESCRIPTION: 18/05/2023 JOB No. DATE: armenti NEWLUX HOMES & CONSTRUCTIONS 22-1182 **BUILDING PERMIT** Proposed Double Storey Residence CONFIRM ALL DIMENSIONS ON SITE PRIOR TO COMMENCING ANY WORK. USE WRITTEN DIMENSIONS IN PREFERENCE TO SCALING SHEET No. FORM & SPACE Lot 69, Hn 32, Bellflower Grove, NOTIFY THE DESIGNER IF ANY DESCREPANCIES OCCUR TO BE READ IN CONJUNCTION WITH ALL CONSULTANT DWGS tizianoarmenti@bigpond.com A01 of 09 LANDSDALE

SMOKE ALARM

SMOKE ALARMS USING SCATTERED LIGHT, TRANSMITTED LIGHT OR IONISATION TO BE HARDWIRED & INTERCONNECTED AS PER AS 3786:2014

BOUNDARY WALL

PHYSICAL TERMITE BARRIER TO BE PROVIDED TO GARAGE WALL

WC DOORS

WC & P'DER DOORS TO HAVE LIFT OF HINGES AND TO COMPLY WITH BCA PART 3.8.3.3

GLAZING

GLAZING TO BE SUPPLIED AND INSTALLED IN ACCORDANCE WITH AS 2047

GENERAL NOTES:

- CONFIRM ALL DIMENSIONS ON SITE PRIOR TO THE COMMENCEMENT OF CONSTRUCTION - REFER TO ENGINEERS DRAWINGS FOR ALL STRUCTURAL REQUIREMENTS
- NOTIFY DESIGNER IF ANY DISCREPANCIES OCCUR - HEAD CONTRACTOR TO ENSURE THAT ALL WORK COMPLIES WITH CURRENT AUSTRALIAN BUILDING CODES AND RELEVANT AUSTRALIAN STANDARDS - NUMBER AND POSITION OF DOWNPIPES APPROX ONLY AND TO BUILDERS DISCRETION

CONSTRUCTION NOTES:

- SUPPLY AND INSTALL TERMITE MANAGEMENT SYSTEM TO COMPLY BCA CLAUSE 3.1.4 AND WITH AS 3660.1-2014 AND MANUFACTURER'S **SPECIFICATIONS**
- ALL BRICKWORK (INCLUDING BRICK VENEER) SHALL BE IN ACCORDANCE WITH AS3700- MASONRY CODE - ALL TIMBER FRAMING SHALL BE IN ACCORDANCE WITH AS1684.
- UNLESS OTHERWISE APPROVED ROOF FRAMING SHALL BE OF TRADITIONAL TIMBER FRAMED CONSTRUCTION
- ELECTRICIAN TO SUPPLY AND INSTALL APPROVED HARD WIRED SMOKE ALARMS IN ACCORDANCE WITH AS3786. - ELECTRICIAN TO SUPPLY AND INSTALL MECHANICAL VENTILATION TO REQUIRED WET AREAS IN ACCORDANCE WITH AS1668.2.


ALL VENTS TO BE DUCTED TO OUTSIDE. - ALL GAS FITTINGS AND OUTLETS TO BE IN ACCORDANCE WITH GAS STANDARD (GAS FITTINGS & CONSUMER GAS INSTALLATIONS) **REGULATIONS 1999.**

NOTES:

-MDF NOSING DENOTED ON WINDOWS -LONGREACH BRICKS OVER INTERNAL DOUBLE DOOR AND WINDOWS LONGER THAN 1.6M AND/OR LESS THAN 3c BRICKWORK. -HARDWALL PLATER INTERNALLY. -PLASTERBEADS TO ALL EXTERNAL CORNERS. -SHELF & RAIL TO ROBES @1800 AFL -FINAL POSITION OF CEILING EXHAUST FANS AND RAINWATER PIPES (rwp) TO BE DETERMINED ON SITE TO SUIT ROOF FRAME MEMBERS. -FLOOR WASTES AND PLUMBING OUTLETS ARE SHOWN DIAGRAMATICALLY AND MAY BE POSITIONED AT THE PLUMBERS AND/OR CONCRETORS DISCRETION

1. wet areas and appliance details provided by owner (confirm fixtures with owner prior to pouring concrete slab). brick build up around building engineers drawings for details. 3. verify all plumbing duct and a/c penetrations before pouring concrete suspended slab 4. provide minimum of R3.5 ceiling insulation to all ceilings including garage & store in matching colour to roof material 7. Tap wear, shower heads & cisterns to comply with NCC Appendix A WA Additions WA2.3 Acceptable Construction Practice. 8. Gas HWS to comply with NCC Part 3.12.5.6 Water Heater in a hot water supply system. 9. Kitchen rangehood to flumed to external air. 10. Exhaust fans to be flumed to external air.

5. provide 2 whirly bird roof ventilators 6. mitre and weld t-bars at corner.

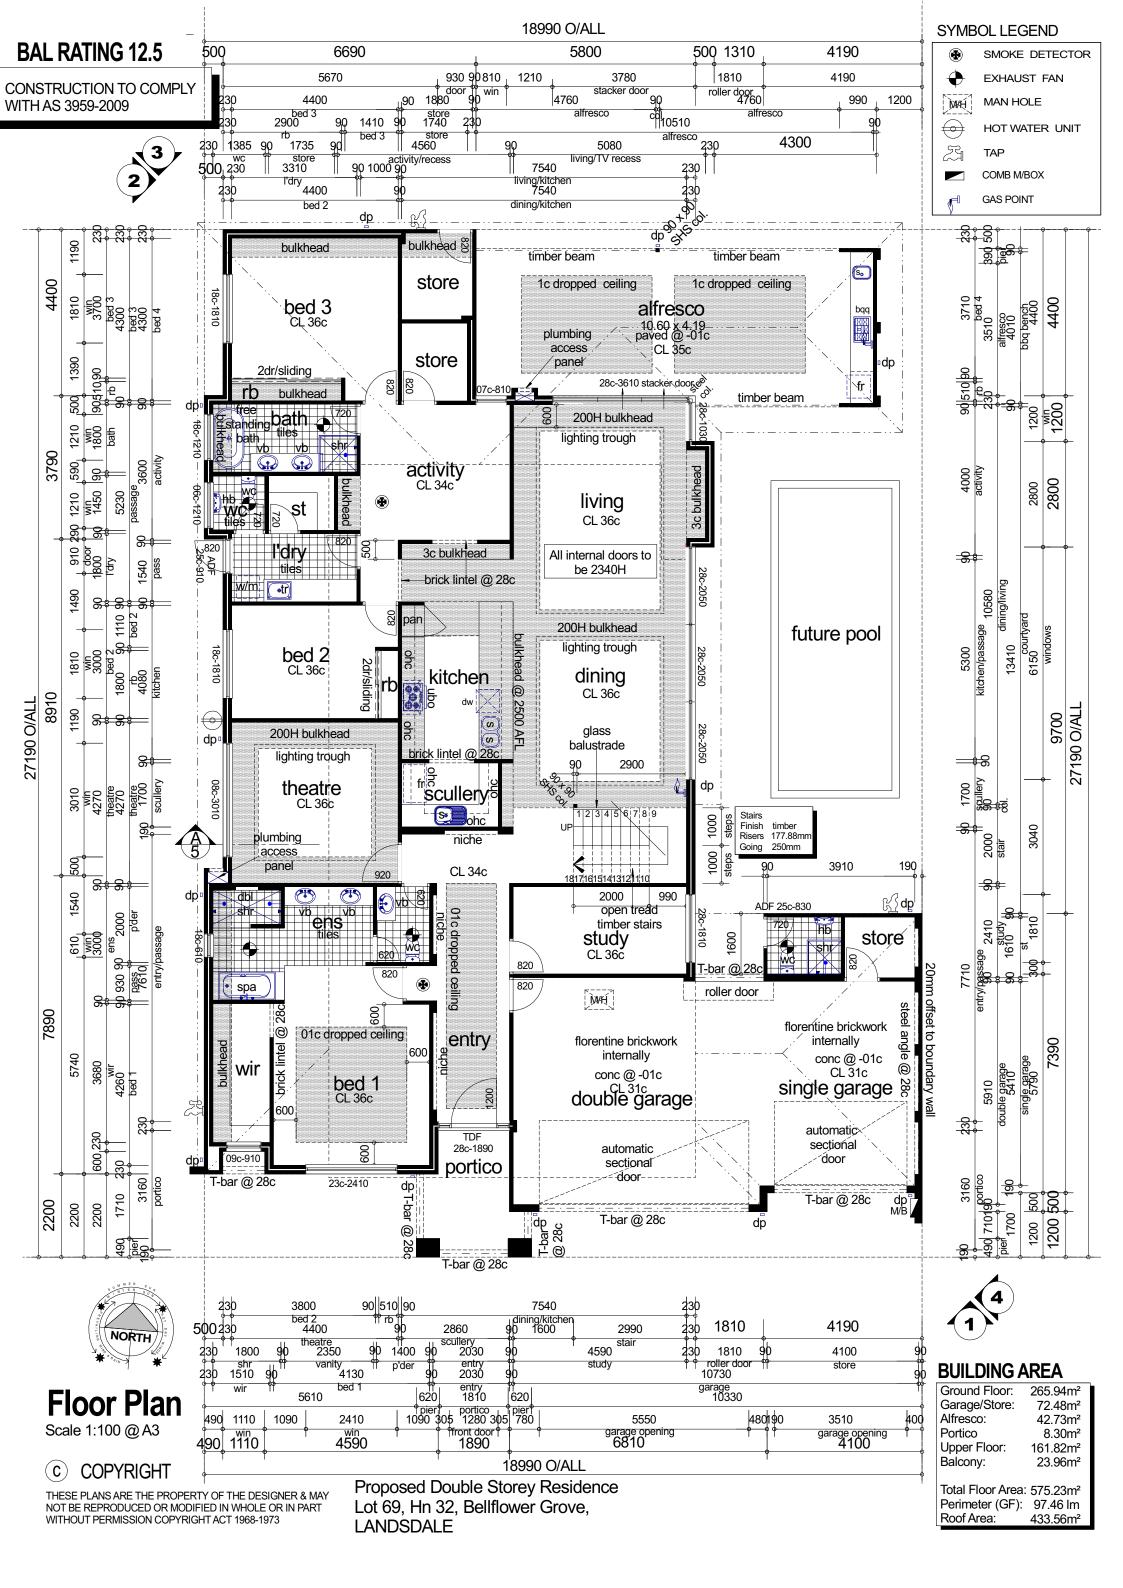


WET AREAS

3.8.1.1 AND AS 3740

WET AREAS WATERPROOFING AND WATER RESISTANCE REQUIREMENTS TO COMPLY WITH BCA 2016 PART 3.8.1 BUILDING ELEMENTS IN WET AREAS WILL COMPLY WITH WATERPROOF OR WATER RESISTANT IN ACCORDANCE WITH TABLE

SYMBOL LEGEND



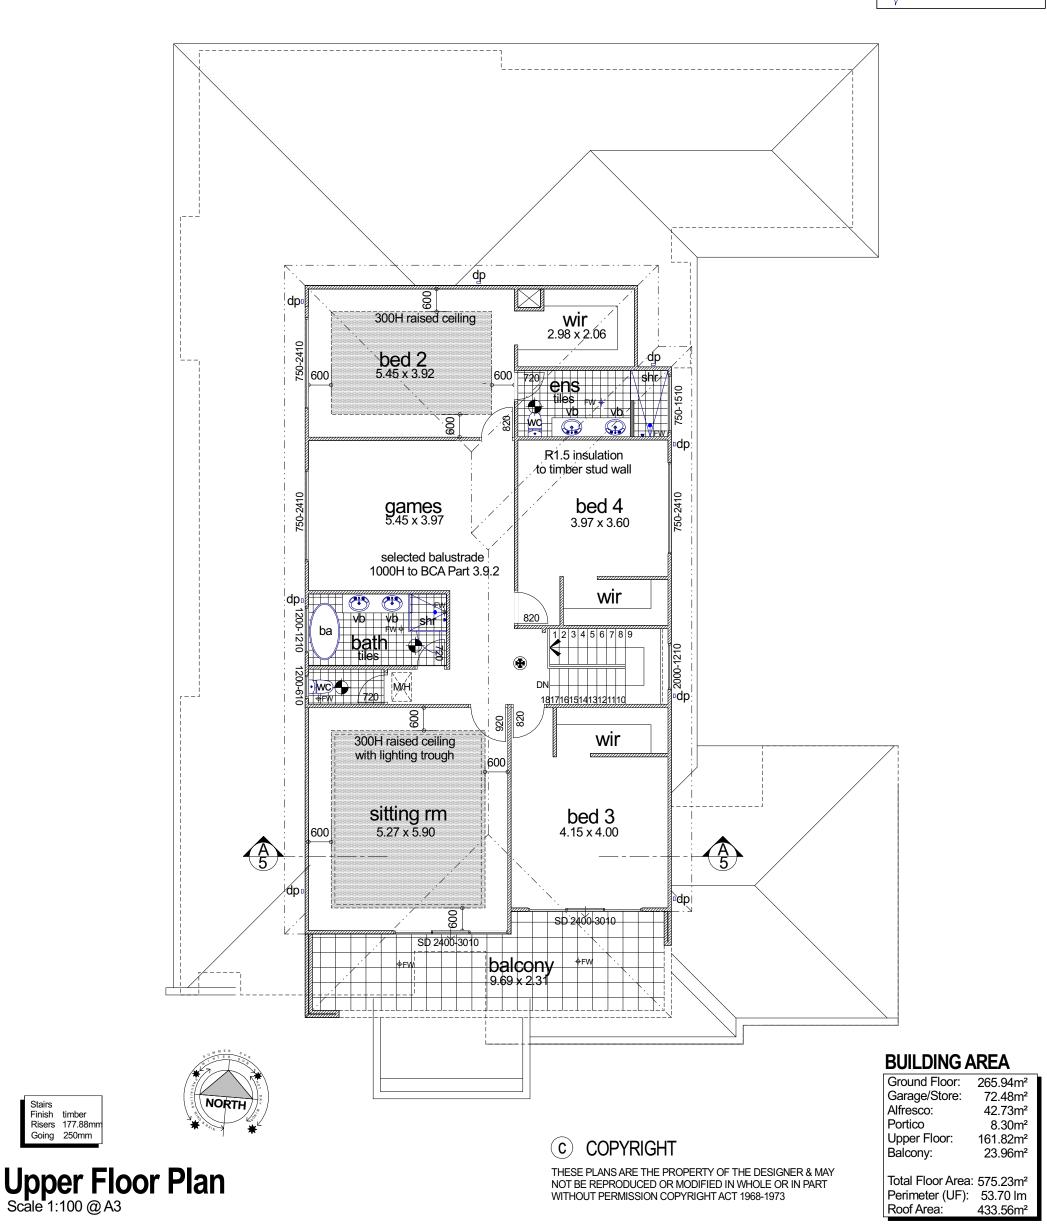

REV. DATE: DESCRIPTION:

NEWLUX HOMES → CONSTRUCTIONS

Stairs

Risers 177.88mm Going 250mm

Proposed Double Storey Residence Lot 69, Hn 32, Bellflower Grove, ANDSDALE

DATE: 18/05/2023 **BUILDING PERMIT** CONFIRM ALL DIMENSIONS ON SITE PRIOR TO COMMENCING ANY WORK. USE WRITTEN DIMENSIONS IN PREFERENCE TO SCALING. NOTIFY THE DESIGNER IF ANY DESCREPANCIES OCCUR
TO BE READ IN CONJUNCTION WITH ALL CONSULTANT DWGS
tizianoarmenti@bigpond.com

JOB No. 22-1182 SHEET No. A03 of 09

armenti

