



ADDITION

EXISTING

ADDITION

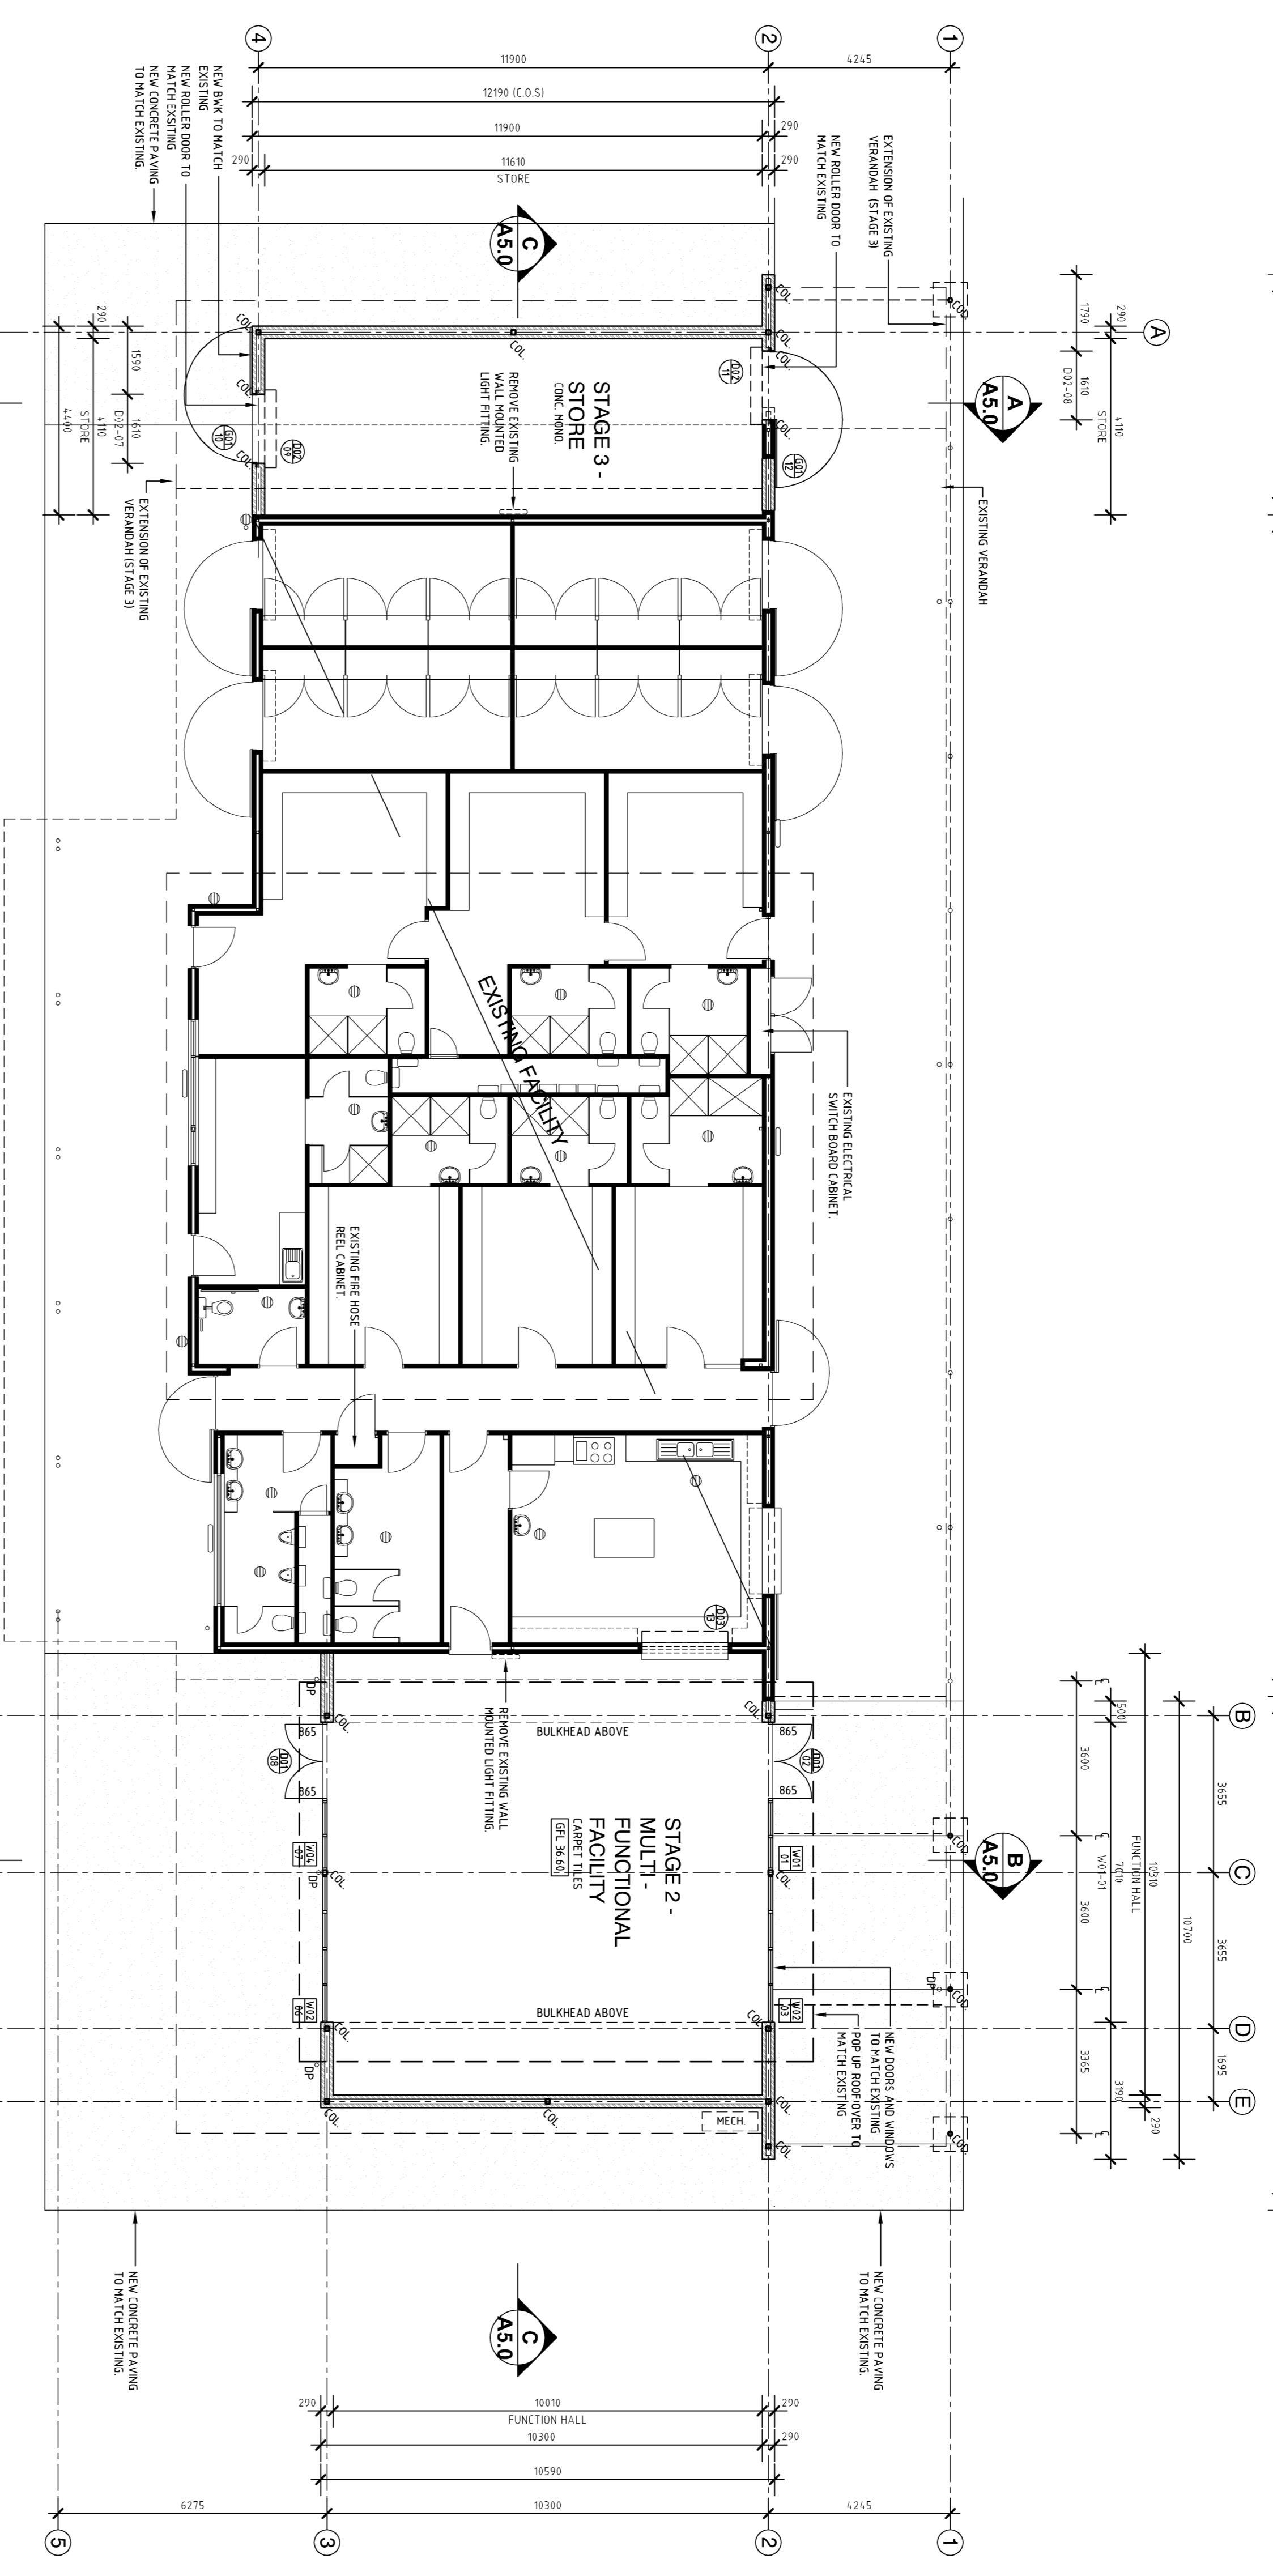

GROUND FLOOR PLAN
SCALE 1:300

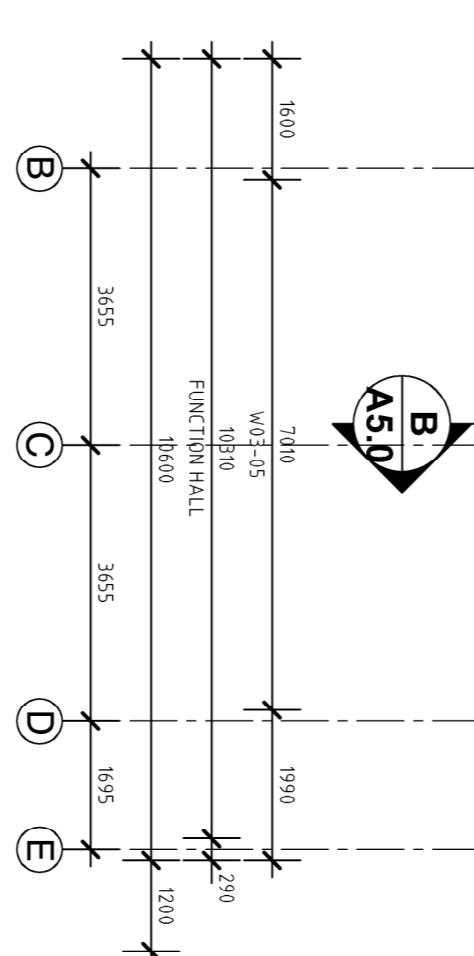

No.	REVISION	DATE	BY	CHKD	NO.	REVISION	DATE	BY	CHKD
1	ISSUED TO CONSULTANTS	16/09/2015	SM		0	ISSUED TO CONSULTANTS	16/09/2015	SM	
A	ISSUED FOR CLIN APPROVAL	05/10/2015	SM		E	ISSUED TO QS & CONSULTANTS	05/10/2015	SM	
B	ISSUED TO CONSULTANTS	06/10/2015	SM		F	ISSUED TO CLIENT	06/10/2015	SM	
C	ISSUED TO STRUCTURAL ENGINEER	08/10/2015	SM						

CITY OF WANNEREROO
INFRASTRUCTURE

PROJECT NUMBER: PR-3090

DATE: 16/09/2015

BY: SM

CHKD: SM

Site Architecture Studio
Site Architecture Studio
Suite 11, 90 King Street Perth 6000 WA
T 08 9228 5661
F 08 9228 5662
mail@sitearchitecture.com.au
www.sitearchitecture.com.au

GUMBLOSSUM RESERVE
MULTI-PURPOSE ROOM EXTENSION
STAGE 2 & 3
QUINNS ROCKS

PROJECT NUMBER: TBA

DATE: 16/09/2015

BY: SM

CHKD: SM

GROUND FLOOR PLAN & DETAILS
SHEET 2 OF 6

DRAWING NO: 3166-A02-F
SHEET: A1

- NOTES**
- BUILDER TO LOCALLY GRADE FINISHED LANDSCAPING TO ENTIRE PERIMETER OF BUILDING TO ENSURE ADEQUATE WATER RUN-OFF TO ROADSIDE.
 - ENSURE THAT ALL POINTS OF EGRESS FROM THE BUILDING ARE NO GREATER THAN 15m FROM MAIN EXTERIOR FINISHED LANDSCAPE LEVEL. REFER TO A5.1/2/3 FOR DETAILS AND PROVIDE STAIRS AS DIRECTED BY ARCHITECT IF REQUIRED.
 - PROVIDE MIN FALL AWAY FROM BUILDING OF 1:100 FOR STORMWATER RUN-OFF TO ALL EXTERIOR PAVING IN THE DIRECTION AS SHOWN. REFER TO W10 END DWGS FOR DETAILS.
 - COLUMN TYPES ONLY INDICATIVE - REFER TO STRUCTURAL DRAWINGS FOR DETAILS.
 - FOR ALL SERVICES TO BE READ IN CONJUNCTION WITH CONSULTANT DRAWINGS.
 - REFER TO ELEVATIONS FOR EXTERNAL FINISHES.
 - TO BE READ IN CONJUNCTION WITH MULTI TRADE SCHEDULE FOR ALL MATERIALS AND FINISHES.
 - ALL INTERNAL WALLS TO FINISH TO UNDERSIDE OF ROOF UNLESS SHOWN OTHERWISE TO BE READ IN CONJUNCTION WITH REFLECTED CEILING PLAN A5.0.
- LEGEND**
- A ACTIVE DOOR LEAF
COL LOCATION OF STRUCTURAL COLUMN. REFER TO STRUCT ENG DWGS FOR DETAILS.
COR LOCATION OF CORNER REFER TO W10 END DWGS FOR DETAILS.
HTH LOCATION OF MECHANICAL EQUIPMENT. REFER TO W10 END DWGS FOR DETAILS.
HECH LOCATION OF MECHANICAL EQUIPMENT. REFER TO W10 END DWGS FOR DETAILS.
- WALL TYPES**
- DENOTES NEW TYPED CAVITY (UNLESS NOTED) BETWEEN 90mm FLECK BRICKWORK MATCH EXISTING & 50mm COMMON BRICKWORK COMPLETE WITH NOMINAL ED CAVITY INSULATION (UNLESS NOTED).
DENOTES EXISTING EXTERIOR STRUCTURAL INTEGRITY, INDICATIVE ONLY.
DENOTES EXISTING EXTERIOR STRUCTURAL INTEGRITY, INDICATIVE ONLY.
DENOTES GLAZED WINDOW PARTITION REFER TO WINDOW SCHEDULE.
- SYMBOLS**
- DENOTES DOOR TYPE AND OPENING NUMBER. REFER TO DOOR SCHEDULE FOR DETAILS.
DENOTES WINDOW TYPE AND OPENING NUMBER. REFER TO WINDOW SCHEDULE FOR DETAILS.
DENOTES CONTROL JAMB REFER TO STRUCT ENG DWGS FOR DETAILS.
DENOTES CONTROL JAMB REFER TO STRUCT ENG DWGS FOR DETAILS.

3166-A02-F