

**GENERAL NOTES** 

## IF IN DOUBT ASK - DO NOT SCALE

AUSTRALIAN STANDARDS: UNLESS OTHERWISE SPECIFIED IN THE CONTRACT, AND WHERE APPLICABLE, MATERIALS AND WORKMANSHIPSHALL BE IN ACCORDANCE WITH THE RELEVANT STANDARD OF THE STANDARDS ASSOCIATION OF AUSTRALIA. IT SHALL BE THE CONTRACTORS RESPONSIBILITY TO ENSURE THAT THE SUBCONTRACTORS ARE FAMILIAR WITH ALL RELEVANT AUSTRALIAN STANDARDS APPLICABLE TO THEIR WORK

DIMENSIONS AND SCALED DRAWINGS: FIGURE DIMENSIONS ON CONTRACT DOCUMENTS SHALL BE READ IN PREFERENCE TO SCALE. LARGER SCALED DRAWINGS SHOULD BE READ IN PREFERENCE TO SMALLER SCALED DRAWINGS. CONTRACTOR TO CHECK FOR DISCREPANCIES ALL FIGURED DIMENSIONS BEFORE DRAWINGS. COMMENCING ANY WORK OR SHOP DRAWINGS
SITE MEASUREMENTS SUCH AS DOORS, WINDOWS, JOINERY, FIXED FURNITURE,
FURNISHINGS, FENCING, PLANT EQUIPEMENT AND THE LIKE TO CONFIRM THE
SUITABILITY OF THE DESIGN BEFORE COMMENCING FABRICATION AND IDENTIFY
CHANGES REQUIRED TO DOCUMENTATION BEFORE FABRICATION

TIMBER CONSTRUCTION NOTES
ALL TIMBER TO BE CARRIED OUT IN ACCORDANCE WITH THE NATIONAL TIMBER
FRAMING CODE AS 1684 AND THE TIMBER STRUCTURES CODE AS 1720.1

ALL DIMENSIONS ARE SHOWN FROM BRICKWORK TO BRICKWORK AND CONCRETE TO CONCRETE. NO ALLOWANCE HAS BEEN MADE FOR HARDWALL PLASTER, SKIM COAT, EXTERNAL RENDER, STONE CLADDING, FLOOR FINISHES OR STAIR

ALL WORKS SHALL BE CARRIED OUT IN A WORKMANLIKE MANNER

FALLS TO SHOWER FLOORS 1:80 FALLS TO WET AREA FLOORS 1:100

TILE LINES ARE INDICATIVE ONLY AND SUBJECT TO FINAL SELECTIONS

CABINETWORK AND ALL FIRST FIT PLUMBING SPUDS AND ELECTRICAL BOXES ARE DIMENSIONED FROM MAIN SLAB LEVELS - NOT SETDOWN LEVELS OR FINISHED FLOOR LEVELS

PROVIDE ALL NECESSARY FIXINGS, FLASHINGS, PACKING AND SEALANTS REQUIRED TO ENSURE THE INSTALLATION IS COMPLETELY WATERTIGHT

ALL GLAZING TO BE IN ACCORDANCE WITH AS1288
ALL DOORS AND WINDOWS TO BE FITTED WITH APPROVED SEALS

NOTE:

THESE DOCUMENTS ARE TO BE **READ IN CONJUNCTION WITH STRUCTURAL ENGINEERS DOCUMENTS AND SPECIFICATIONS** 

**TERMITE TREATMENT NOTE:** REFER SPECIFICATIONS FOR ALL **TERMITE TREATMENTS DETAILS AND LOCATIONS REQUIRED. INSTALL** STRICTLY TO RELEVANT CODES AND **REGULATIONS** 

**NOTE: REFER BUILDERS** SPECIFICATION FOR ALL OWNER SUPPLIED AND **INSTALLED ITEMS. CLARIFY EXACT SCOPE PRIOR TO ANY WORKS STARTING** 

**CONSTRUCTION NOTES** 

25° UPPER FLOOR ROOF PITCH COLORBOND ROOF

ALL TIMBER TO BE CARRIED OUT IN ACCORDANCE WITH THE NATIONAL TIMBER FRAMING CODE AS 1684 AND THE TIMBER STRUCTURES CODE AS 1720.1


32c UNDERCROFT FLOOR TO CEILING 32c GROUND FLOOR TO CEILING 32c + PLATE UPPER FLOOR TO CEILING

RENDERED BRICKWORK EXTERNALLY UNLESS OTHERWISW NOTED

N? WIND CATEGORY

**BALUSTRADE NOTES** 

BALUSTRADE CONSTRUCTION TO COMPLY TO NCC PART 3.9
 MINIMUM HEIGHT OF BALUSTRADE TO BE 1000MM ABOVE FLOOR LEVEL.
 OPENINGS IN BALUSTRADE TO BE A MAXIMUM OF 125MM.

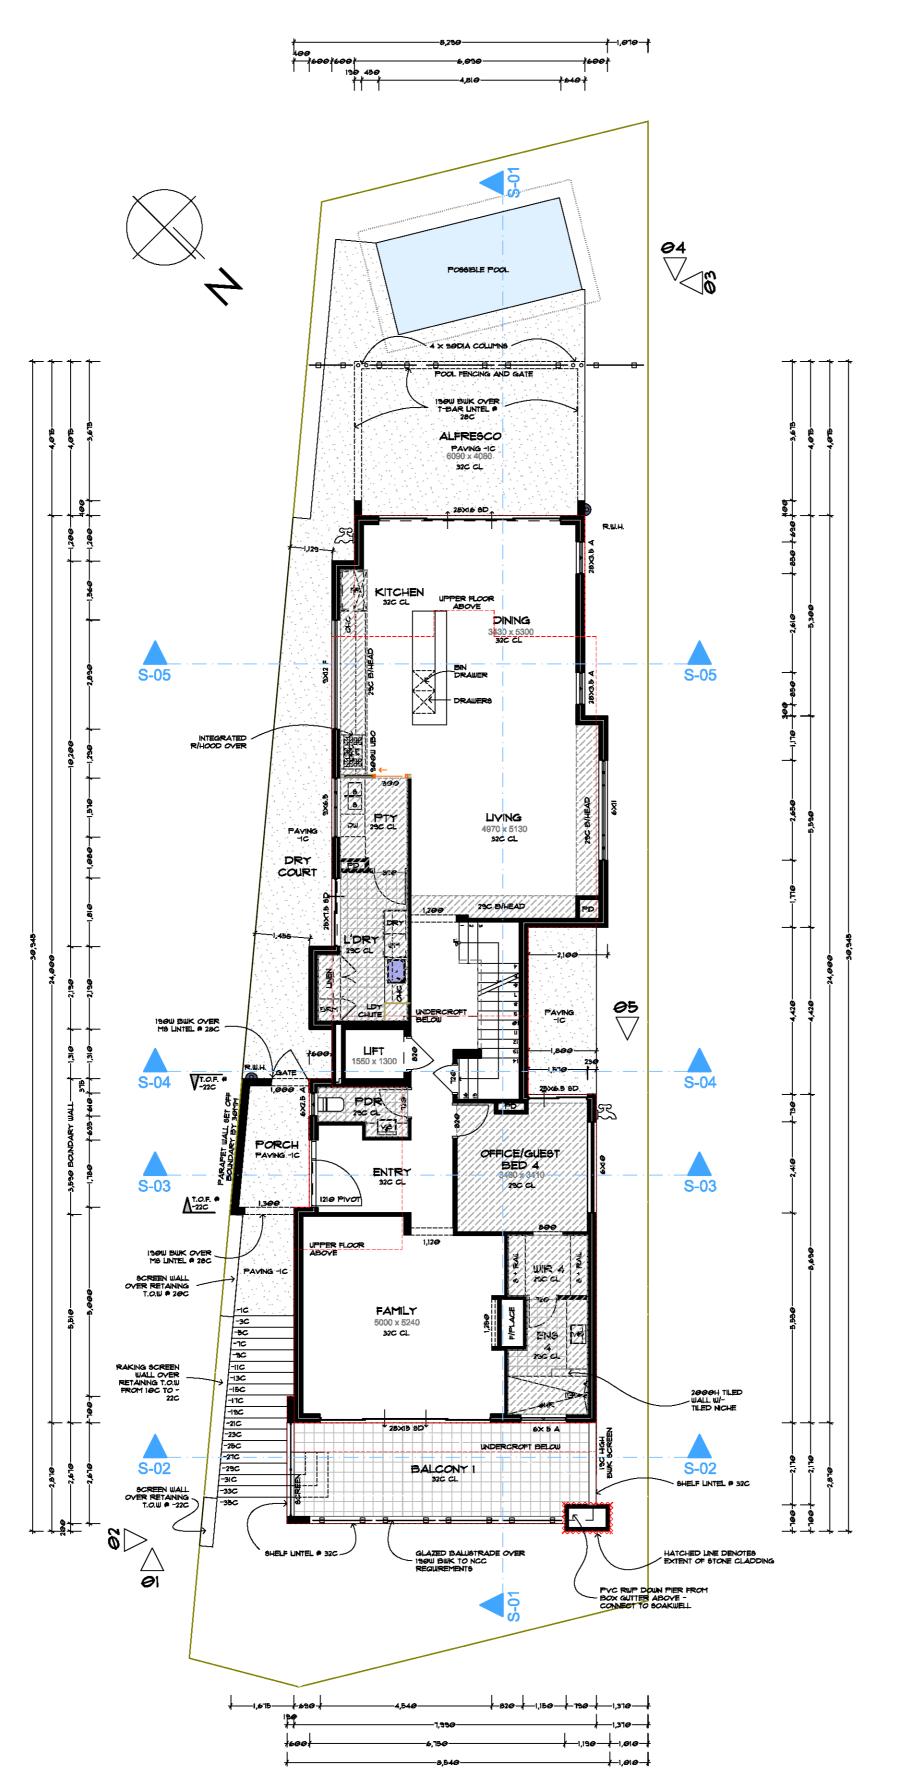

**GENERAL NOTES** 

# IF IN DOUBT ASK - DO NOT SCALE

AUSTRALIAN STANDARDS: UNLESS OTHERWISE SPECIFIED IN THE CONTRACT, AND WHERE APPLICABLE, MATERIALS AND WORKMANSHIPSHALL BE IN ACCORDANCE WITH THE RELEVANT STANDARD OF THE STANDARDS ASSOCIATION OF AUSTRALIA. IT SHALL BE THE CONTRACTORS RESPONSIBILITY TO ENSURE THAT THE SUBCONTRACTORS ARE FAMILIAR WITH ALL RELEVANT AUSTRALIAN STANDARDS APPLICABLE TO THEIR WORK

DIMENSIONS AND SCALED DRAWINGS: FIGURE DIMENSIONS ON CONTRACT DOCUMENTS SHALL BE READ IN PREFERENCE TO SCALE. LARGER SCALED DRAWINGS SHOULD BE READ IN PREFERENCE TO SMALLER SCALED DRAWINGS. CONTRACTOR TO CHECK FOR DISCREPANCIES ALL FIGURED DIMENSIONS BEFORE COMMENCING ANY WORK OR SHOP DRAWINGS
SITE MEASUREMENTS SUCH AS DOORS, WINDOWS, JOINERY, FIXED FURNITURE,
FURNISHINGS, FENCING, PLANT EQUIPEMENT AND THE LIKE TO CONFIRM THE
SUITABILITY OF THE DESIGN BEFORE COMMENCING FABRICATION AND IDENTIFY
CHANGES REQUIRED TO DOCUMENTATION BEFORE FABRICATION

TIMBER CONSTRUCTION NOTES
ALL TIMBER TO BE CARRIED OUT IN ACCORDANCE WITH THE NATIONAL TIMBER
FRAMING CODE AS 1684 AND THE TIMBER STRUCTURES CODE AS 1720.1

ALL DIMENSIONS ARE SHOWN FROM BRICKWORK TO BRICKWORK AND CONCRETE TO CONCRETE. NO ALLOWANCE HAS BEEN MADE FOR HARDWALL PLASTER, SKIM COAT, EXTERNAL RENDER, STONE CLADDING, FLOOR FINISHES OR STAIR

ALL WORKS SHALL BE CARRIED OUT IN A WORKMANLIKE MANNER FALLS TO SHOWER FLOORS 1:80 FALLS TO WET AREA FLOORS 1:100

TILE LINES ARE INDICATIVE ONLY AND SUBJECT TO FINAL SELECTIONS

CABINETWORK AND ALL FIRST FIT PLUMBING SPUDS AND ELECTRICAL BOXES ARE DIMENSIONED FROM MAIN SLAB LEVELS - NOT SETDOWN LEVELS OR FINISHED FLOOR LEVELS

PROVIDE ALL NECESSARY FIXINGS, FLASHINGS, PACKING AND SEALANTS REQUIRED TO ENSURE THE INSTALLATION IS COMPLETELY WATERTIGHT

ALL GLAZING TO BE IN ACCORDANCE WITH AS1288
ALL DOORS AND WINDOWS TO BE FITTED WITH APPROVED SEALS

NOTE: THESE DOCUMENTS ARE TO BE **READ IN CONJUNCTION WITH** STRUCTURAL ENGINEERS

**TERMITE TREATMENT NOTE: REFER SPECIFICATIONS FOR ALL TERMITE TREATMENTS DETAILS AND LOCATIONS REQUIRED. INSTALL** STRICTLY TO RELEVANT CODES AND **REGULATIONS** 

**DOCUMENTS AND SPECIFICATIONS** 

**NOTE: REFER BUILDERS** SPECIFICATION FOR ALL OWNER SUPPLIED AND **INSTALLED ITEMS. CLARIFY EXACT SCOPE PRIOR TO ANY WORKS STARTING** 

## **CONSTRUCTION NOTES**

25° UPPER FLOOR ROOF PITCH COLORBOND ROOF

ALL TIMBER TO BE CARRIED OUT IN ACCORDANCE WITH THE NATIONAL TIMBER FRAMING CODE AS 1684 AND THE TIMBER STRUCTURES CODE AS 1720.1

32c UNDERCROFT FLOOR TO CEILING

RENDERED BRICKWORK EXTERNALLY UNLESS OTHERWISW NOTED N? WIND CATEGORY


## **BALUSTRADE NOTES**

BALUSTRADE CONSTRUCTION TO COMPLY TO NCC PART 3.9
 MINIMUM HEIGHT OF BALUSTRADE TO BE 1000MM ABOVE FLOOR LEVEL.
 OPENINGS IN BALUSTRADE TO BE A MAXIMUM OF 125MM.

Floor Areas					
Floor	Location	Area	Perimeter		
UNDERCROFT		•			
	UNDERCROFT	85.38			
		85.38 m²			
<b>GROUND FLOOR</b>		•			
	GROUND FLOOR	168.23			
	ALFRESCO	24.82			
	BALCONY 1	21.84			
	PORCH	6.90			
		221.79 m²			
UPPER FLOOR					
	UPPER FLOOR	135.17			
	BALCONY 2	21.84			
	BALCONY 3	18.39			
		175.40 m²			
		482.57 m²			

**GROUND FLOOR PLAN** 1:100

	DRAWING TITLE: FLOOR PLAN		AMENDMENTS:  REV A 25.00.19 CAD CONCEPT REVIEW  REV B 30.10.19 PLANNING APPLICATION	
				12
	DRAWN;	SCALE;		of l
SITE ADDRESS:		AS SHOWN		က
LOT 207 (No 30a) CLARECASTLE	STATUS: PLANNING APPLICATION	REVISION:		H
RETREAT MINDARIE	PUBLISH DATE: Friday, 1 November 2019	7 <b>6</b>		SH

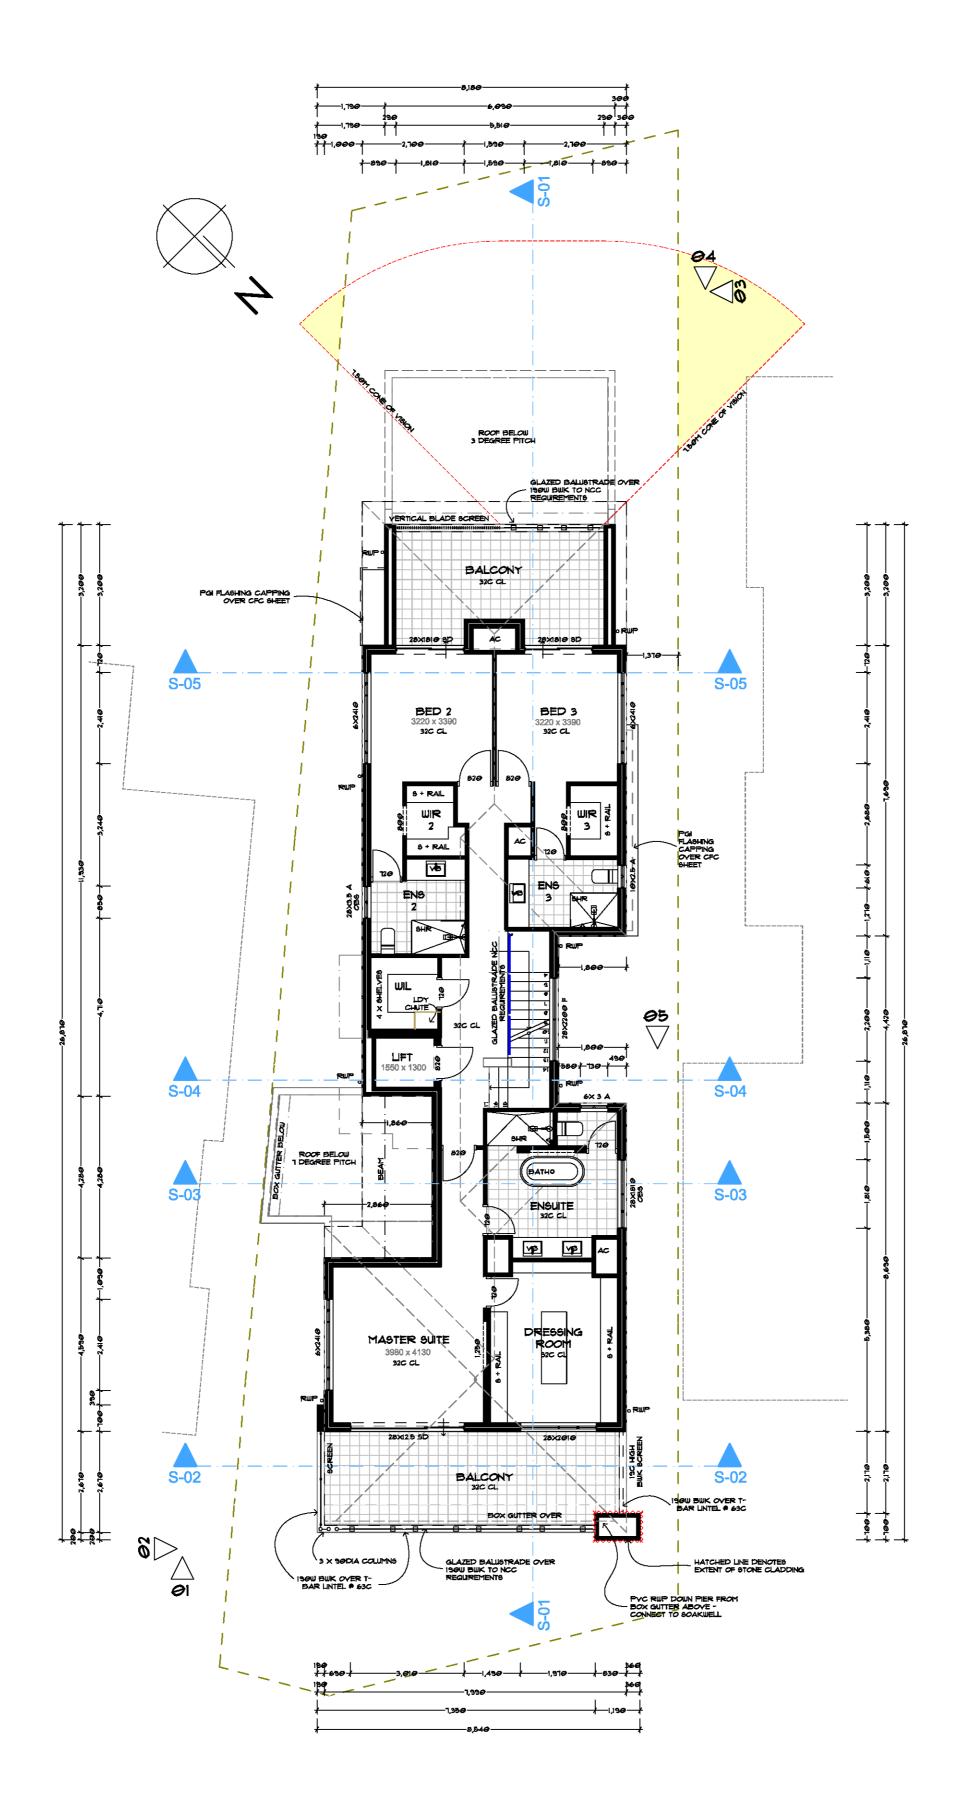

**GENERAL NOTES** 

## IF IN DOUBT ASK - DO NOT SCALE

AUSTRALIAN STANDARDS: UNLESS OTHERWISE SPECIFIED IN THE CONTRACT, AND WHERE APPLICABLE, MATERIALS AND WORKMANSHIPSHALL BE IN ACCORDANCE WITH THE RELEVANT STANDARD OF THE STANDARDS ASSOCIATION OF AUSTRALIA. IT SHALL BE THE CONTRACTORS RESPONSIBILITY TO ENSURE THAT THE SUBCONTRACTORS ARE FAMILIAR WITH ALL RELEVANT AUSTRALIAN STANDARDS APPLICABLE TO THEIR WORK

DIMENSIONS AND SCALED DRAWINGS: FIGURE DIMENSIONS ON CONTRACT DOCUMENTS SHALL BE READ IN PREFERENCE TO SCALE. LARGER SCALED DRAWINGS SHOULD BE READ IN PREFERENCE TO SMALLER SCALED DRAWINGS. CONTRACTOR TO CHECK FOR DISCREPANCIES ALL FIGURED DIMENSIONS BEFORE COMMENCING ANY WORK OR SHOP DRAWINGS
SITE MEASUREMENTS SUCH AS DOORS, WINDOWS, JOINERY, FIXED FURNITURE,
FURNISHINGS, FENCING, PLANT EQUIPEMENT AND THE LIKE TO CONFIRM THE
SUITABILITY OF THE DESIGN BEFORE COMMENCING FABRICATION AND IDENTIFY
CHANGES REQUIRED TO DOCUMENTATION BEFORE FABRICATION

TIMBER CONSTRUCTION NOTES
ALL TIMBER TO BE CARRIED OUT IN ACCORDANCE WITH THE NATIONAL TIMBER
FRAMING CODE AS 1684 AND THE TIMBER STRUCTURES CODE AS 1720.1

ALL DIMENSIONS ARE SHOWN FROM BRICKWORK TO BRICKWORK AND CONCRETE TO CONCRETE. NO ALLOWANCE HAS BEEN MADE FOR HARDWALL PLASTER, SKIM COAT, EXTERNAL RENDER, STONE CLADDING, FLOOR FINISHES OR STAIR

ALL WORKS SHALL BE CARRIED OUT IN A WORKMANLIKE MANNER FALLS TO SHOWER FLOORS 1:80 FALLS TO WET AREA FLOORS 1:100

TILE LINES ARE INDICATIVE ONLY AND SUBJECT TO FINAL SELECTIONS

CABINETWORK AND ALL FIRST FIT PLUMBING SPUDS AND ELECTRICAL BOXES ARE DIMENSIONED FROM MAIN SLAB LEVELS - NOT SETDOWN LEVELS OR FINISHED FLOOR LEVELS

PROVIDE ALL NECESSARY FIXINGS, FLASHINGS, PACKING AND SEALANTS REQUIRED TO ENSURE THE INSTALLATION IS COMPLETELY WATERTIGHT

ALL GLAZING TO BE IN ACCORDANCE WITH AS1288
ALL DOORS AND WINDOWS TO BE FITTED WITH APPROVED SEALS

NOTE:

THESE DOCUMENTS ARE TO BE **READ IN CONJUNCTION WITH** STRUCTURAL ENGINEERS **DOCUMENTS AND SPECIFICATIONS** 

**TERMITE TREATMENT NOTE: REFER SPECIFICATIONS FOR ALL TERMITE TREATMENTS DETAILS AND LOCATIONS REQUIRED. INSTALL** STRICTLY TO RELEVANT CODES AND **REGULATIONS** 

**NOTE: REFER BUILDERS** SPECIFICATION FOR ALL OWNER SUPPLIED AND **INSTALLED ITEMS. CLARIFY EXACT SCOPE PRIOR TO ANY WORKS STARTING** 

CONSTRUCTION NOTES
7° GROUND FLOOR ROOF PITCH
3° ALFRESCO ROOF PITCH

25° UPPER FLOOR ROOF PITCH COLORBOND ROOF

ALL TIMBER TO BE CARRIED OUT IN ACCORDANCE WITH THE NATIONAL TIMBER FRAMING CODE AS 1684 AND THE TIMBER STRUCTURES CODE AS 1720.1

32c UNDERCROFT FLOOR TO CEILING


RENDERED BRICKWORK EXTERNALLY UNLESS OTHERWISW NOTED


N? WIND CATEGORY


**BALUSTRADE NOTES** 

BALUSTRADE CONSTRUCTION TO COMPLY TO NCC PART 3.9
 MINIMUM HEIGHT OF BALUSTRADE TO BE 1000MM ABOVE FLOOR LEVEL.
 OPENINGS IN BALUSTRADE TO BE A MAXIMUM OF 125MM.



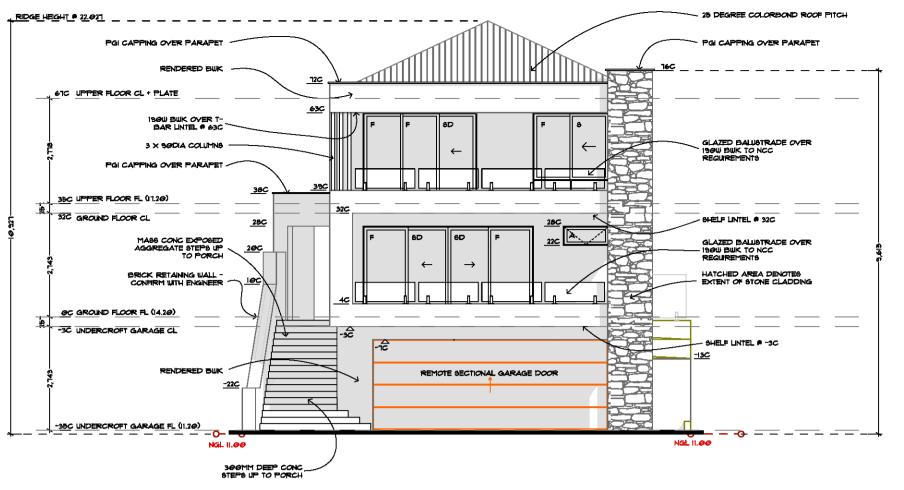

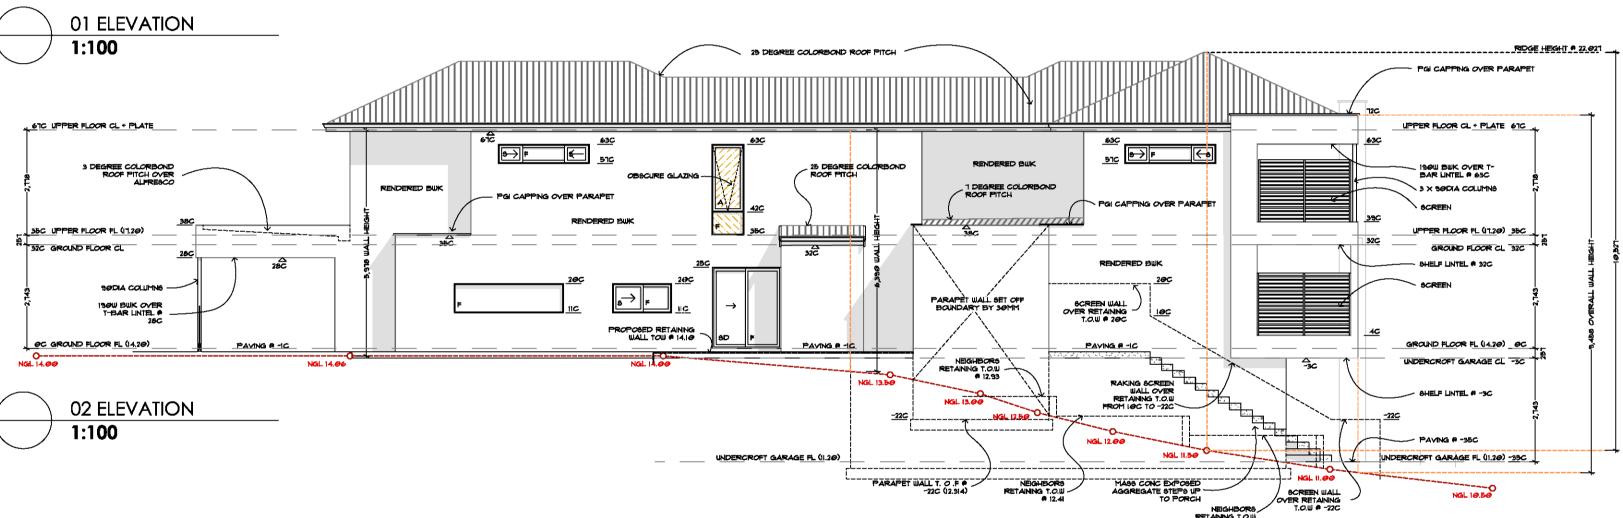

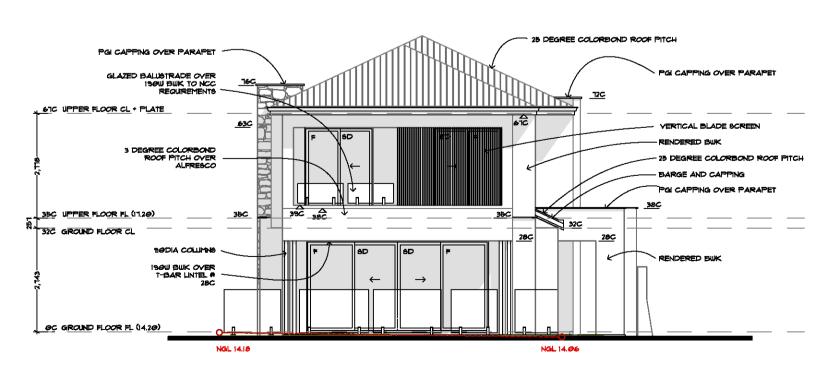

04 ELEVATION 1:100

**PROPOSED RESIDENCE** DRAWING TITLE: ELEVATIONS SCALE: AS SHOWN LOT 207 (No 30a) CLARECASTLE REVISION: PLANNING APPLICATION RETREAT MINDARIE PUBLISH DATE; Friday, 1 November 2019

**GENERAL NOTES** 

## **IF IN DOUBT ASK - DO NOT SCALE**

AUSTRALIAN STANDARDS: UNLESS OTHERWISE SPECIFIED IN THE CONTRACT, AND WHERE APPLICABLE, MATERIALS AND WORKMANSHIPSHALL BE IN ACCORDANCE WITH THE RELEVANT STANDARD OF THE STANDARDS ASSOCIATION OF AUSTRALIA. IT SHALL BE THE CONTRACTORS RESPONSIBILITY TO ENSURE THAT THE SUBCONTRACTORS ARE FAMILIAR WITH ALL RELEVANT AUSTRALIAN STANDARDS ADDITIONAL FOR THE MODIL!

DIMENSIONS AND SCALED DRAWINGS: FIGURE DIMENSIONS ON CONTRACT DOCUMENTS SHALL BE READ IN PREFERENCE TO SCALE. LARGER SCALED DRAWINGS SHOULD BE READ IN PREFERENCE TO SMALLER SCALED DRAWINGS. CONTRACTOR TO CHECK FOR DISCREPANCIES ALL FIGURED DIMENSIONS BEFORE COMMENCING ANY WORK OR SHOP DRAWINGS

COMMENCING ANY WORK OR SHOP DRAWINGS
SITE MEASUREMENTS SUCH AS DOORS, WINDOWS, JOINERY, FIXED FURNITURE,
FURNISHINGS, FENCING, PLANT EQUIPEMENT AND THE LIKE TO CONFIRM THE
SUITABILITY OF THE DESIGN BEFORE COMMENCING FABRICATION AND IDENTIFY
CHANGES REQUIRED TO DOCUMENTATION BEFORE FABRICATION

TIMBER CONSTRUCTION NOTES
ALL TIMBER TO BE CARRIED OUT IN ACCORDANCE WITH THE NATIONAL TIMBER
FRAMING CODE AS 1684 AND THE TIMBER STRUCTURES CODE AS 1720.1

ALL DIMENSIONS ARE SHOWN FROM BRICKWORK TO BRICKWORK AND CONCRETE TO CONCRETE. NO ALLOWANCE HAS BEEN MADE FOR HARDWALL PLASTER, SKIM COAT, EXTERNAL RENDER, STONE CLADDING, FLOOR FINISHES OR STAIR

ALL WORKS SHALL BE CARRIED OUT IN A WORKMANLIKE MANNER

FALLS TO SHOWER FLOORS 1:80 FALLS TO WET AREA FLOORS 1:100

TILE LINES ARE INDICATIVE ONLY AND SUBJECT TO FINAL SELECTIONS

CABINETWORK AND ALL FIRST FIT PLUMBING SPUDS AND ELECTRICAL BOXES ARE DIMENSIONED FROM MAIN SLAB LEVELS - NOT SETDOWN LEVELS OR FINISHED FLOOR LEVELS

PROVIDE ALL NECESSARY FIXINGS, FLASHINGS, PACKING AND SEALANTS REQUIRED TO ENSURE THE INSTALLATION IS COMPLETELY WATERTIGHT

ALL GLAZING TO BE IN ACCORDANCE WITH AS1288
ALL DOORS AND WINDOWS TO BE FITTED WITH APPROVED SEALS

### **NOTE:**

THESE DOCUMENTS ARE TO BE **READ IN CONJUNCTION WITH** STRUCTURAL ENGINEERS **DOCUMENTS AND SPECIFICATIONS** 

**TERMITE TREATMENT NOTE: REFER SPECIFICATIONS FOR ALL** TERMITE TREATMENTS DETAILS AND **LOCATIONS REQUIRED. INSTALL** STRICTLY TO RELEVANT CODES AND **REGULATIONS** 

**NOTE: REFER BUILDERS** SPECIFICATION FOR ALL OWNER SUPPLIED AND **INSTALLED ITEMS. CLARIFY EXACT SCOPE PRIOR TO ANY WORKS STARTING** 

## **CONSTRUCTION NOTES**

3° ALFRESCO ROOF PITCH 25° UPPER FLOOR ROOF PITCH COLORBOND ROOF

ALL TIMBER TO BE CARRIED OUT IN ACCORDANCE WITH THE NATIONAL TIMBER FRAMING CODE AS 1884 AND THE TIMBER STRUCTURES CODE AS 1720.1

32c UNDERCROFT FLOOR TO CEILING 32c GROUND FLOOR TO CEILING 32c + PLATE UPPER FLOOR TO CEILING

RENDERED BRICKWORK EXTERNALLY UNLESS OTHERWISW NOTED


N? WIND CATEGORY

AMENDMENTS: REY A 25.08.13 CAD CONCEPT REVIEW REY B 30.10.13 PLANNING APPLICATION


## **BALUSTRADE NOTES**

BALUSTRADE CONSTRUCTION TO COMPLY TO NCC PART 3.9
 MINIMUM HEIGHT OF BALUSTRADE TO BE 1000MM ABOVE FLOOR LEVEL.
 OPENINGS IN BALUSTRADE TO BE A MAXIMUM OF 126MM.

SHEET 5 of 12

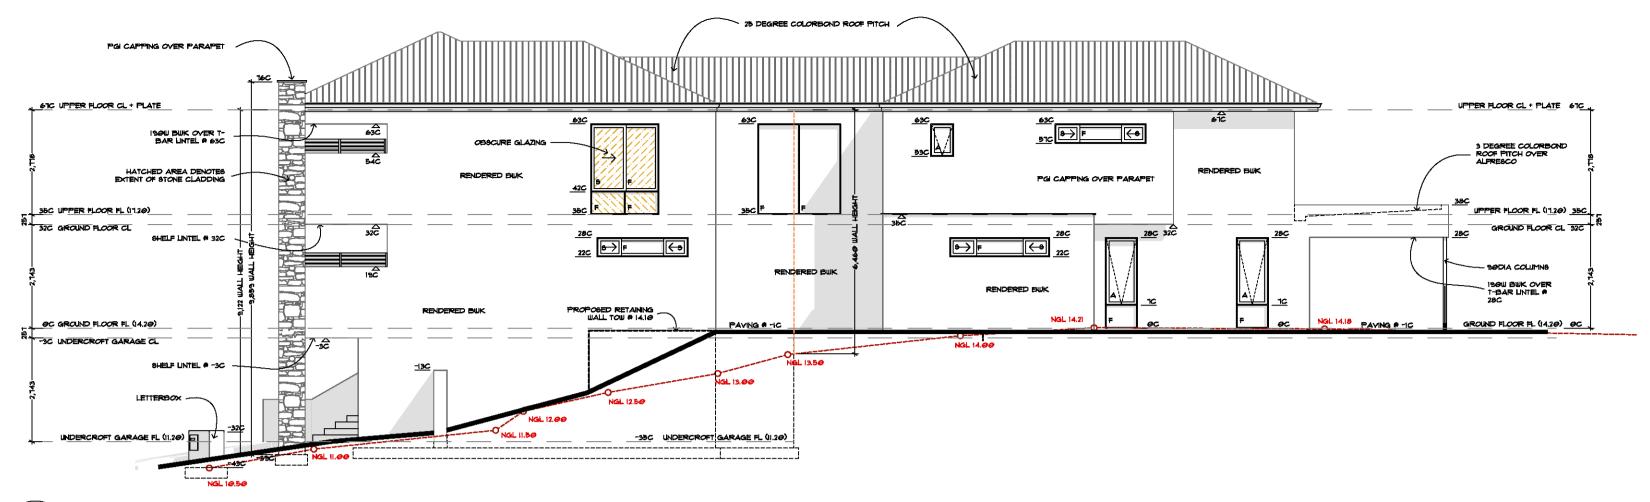

03 ELEVATION 1:100

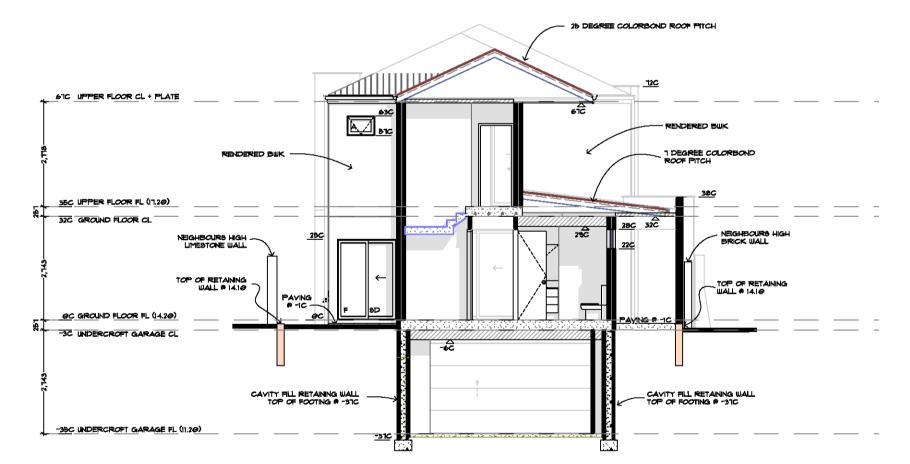

05 ELEVATION 1:100

> PROPOSED RESIDENCE AMENDMENTS: REV A 25.08.19 CAD CONCEPT REVIEW REV B 30.10.19 PLANNING APPLICATION DRAWING TITLE: ELEVATIONS 2 SCALE: AS SHOWN LOT 207 (No 30a) CLARECASTLE REVISION: PLANNING APPLICATION RETREAT MINDARIE PUBLISH DATE; Friday, 1 November 2019

**GENERAL NOTES** 

# IF IN DOUBT ASK - DO NOT SCALE

AUSTRALIAN STANDARDS: UNLESS OTHERWISE SPECIFIED IN THE CONTRACT, AND WHERE APPLICABLE, MATERIALS AND WORKMANSHIPSHALL BE IN ACCORDANCE WITH THE RELEVANT STANDARD OF THE STANDARDS ASSOCIATION OF AUSTRALIA. IT SHALL BE THE CONTRACTORS RESPONSIBILITY TO ENSURE THAT THE SUBCONTRACTORS ARE FAMILIAR WITH ALL RELEVANT AUSTRALIAN STANDARDS ADDITIONAL FOR THE MODIL!

DIMENSIONS AND SCALED DRAWINGS: FIGURE DIMENSIONS ON CONTRACT DOCUMENTS SHALL BE READ IN PREFERENCE TO SCALE. LARGER SCALED DRAWINGS SHOULD BE READ IN PREFERENCE TO SMALLER SCALED DRAWINGS. CONTRACTOR TO CHECK FOR DISCREPANCIES ALL FIGURED DIMENSIONS BEFORE COMMENCING ANY WORK OR SHOP DRAWINGS

COMMENCING ANY WORK OR SHOP DRAWINGS
SITE MEASUREMENTS SUCH AS DOORS, WINDOWS, JOINERY, FIXED FURNITURE,
FURNISHINGS, FENCING, PLANT EQUIPEMENT AND THE LIKE TO CONFIRM THE
SUITABILITY OF THE DESIGN BEFORE COMMENCING FABRICATION AND IDENTIFY
CHANGES REQUIRED TO DOCUMENTATION BEFORE FABRICATION

TIMBER CONSTRUCTION NOTES
ALL TIMBER TO BE CARRIED OUT IN ACCORDANCE WITH THE NATIONAL TIMBER
FRAMING CODE AS 1684 AND THE TIMBER STRUCTURES CODE AS 1720.1

ALL DIMENSIONS ARE SHOWN FROM BRICKWORK TO BRICKWORK AND CONCRETE TO CONCRETE. NO ALLOWANCE HAS BEEN MADE FOR HARDWALL PLASTER, SKIM
COAT, EXTERNAL RENDER, STONE CLADDING, FLOOR FINISHES OR STAIR

ALL WORKS SHALL BE CARRIED OUT IN A WORKMANLIKE MANNER

FALLS TO SHOWER FLOORS 1:80

FALLS TO WET AREA FLOORS 1:100

CABINETWORK AND ALL FIRST FIT PLUMBING SPUDS AND ELECTRICAL BOXES ARE DIMENSIONED FROM MAIN SLAB LEVELS - NOT SETDOWN LEVELS OR FINISHED FLOOR LEVELS

TILE LINES ARE INDICATIVE ONLY AND SUBJECT TO FINAL SELECTIONS

PROVIDE ALL NECESSARY FIXINGS, FLASHINGS, PACKING AND SEALANTS REQUIRED TO ENSURE THE INSTALLATION IS COMPLETELY WATERTIGHT

ALL GLAZING TO BE IN ACCORDANCE WITH AS1288
ALL DOORS AND WINDOWS TO BE FITTED WITH APPROVED SEALS

### **NOTE:**

THESE DOCUMENTS ARE TO BE **READ IN CONJUNCTION WITH** STRUCTURAL ENGINEERS **DOCUMENTS AND SPECIFICATIONS** 

**TERMITE TREATMENT NOTE:** REFER SPECIFICATIONS FOR ALL TERMITE TREATMENTS DETAILS AND **LOCATIONS REQUIRED. INSTALL** STRICTLY TO RELEVANT CODES AND **REGULATIONS** 

**NOTE: REFER BUILDERS** SPECIFICATION FOR ALL OWNER SUPPLIED AND **INSTALLED ITEMS. CLARIFY EXACT SCOPE PRIOR TO ANY WORKS STARTING** 

## **CONSTRUCTION NOTES**

3" ALFRESCO ROOF PITCH 25" UPPER FLOOR ROOF PITCH COLORBOND ROOF

ALL TIMBER TO BE CARRIED OUT IN ACCORDANCE WITH THE NATIONAL TIMBER FRAMING CODE AS 1884 AND THE TIMBER STRUCTURES CODE AS 1720.1

32c UNDERCROFT FLOOR TO CEILING 32c GROUND FLOOR TO CEILING 32c + PLATE UPPER FLOOR TO CEILING

RENDERED BRICKWORK EXTERNALLY UNLESS OTHERWISW NOTED

N? WIND CATEGORY

## **BALUSTRADE NOTES**

BALUSTRADE CONSTRUCTION TO COMPLY TO NCC PART 3.9
 MINIMUM HEIGHT OF BALUSTRADE TO BE 1000MM ABOVE FLOOR LEVEL.
 OPENINGS IN BALUSTRADE TO BE A MAXIMUM OF 125MM.

SHEET 6 of 12