

SARASOTA PASS



AUSTRALIAN HEIGHT DATUM (AHD) DERIVED FROM SEWER MANHOLE

trw - DENOTES TOP OF RETAINING WALL

POSITION OF FENCES & WALLS IN RELATION TO BOUNDARIES NOT GUARANTEED UNLESS REPEG CARRIED OUT AT TIME OF SURVEY.

POSITION OF FEATURES IN RESPECT TO BOUNDARIES NOT GUARANTEED. PEGS MISSING AT TIME OF SURVEY.

ONLY OBVIOUS VISIBLE SERVICES HAVE BEEN LOCATED.
PRIOR TO ANY EXCAVATION, CONSTRUCTION OR DEMOLITION
THE RELEVANT SERVICE AUTHORITIES MUST BE CONTACTED
TO CONFIRM THE LOCATION OF ALL UNDERGROUND SERVICES.

0 5 10 15 20

INTEREST & NOTIFICATIONS OVER LOT.
CHECK DEPOSITED PLAN FOR DETAILS.


AA0699 LID LEVEL

RESTRICTIVE COVENANT OVER LOT. CHECK CERTIFICATE OF TITLE FOR DETAILS. THIS MAY RESTRICT WHAT CAN BE BUILT ON LOT.

SITE PLAN 1:200 at A3

IMPORTANT NOTE:
LOCATION OF BOUNDARY PEGS & IMPROVEMENTS NOT GUARANTEED
UNLESS BOUNDARIES ARE REPEGGED AT TIME OF SURVEY.
CHECK TITLE FOR EASEMENTS, CAVEATS & COVENANTS
PLUMBING CONTRACTORS TO CONFIRM SEWER DEPTHS BEFORE PIPE LAYING R. G. LESTER & ASSOCIATES (BUILDER) LICENSED LAND & ENGINEERING SURVEYORS All sewer details plotted from information supplied by Water Corporation Spatial Information Management. SHOP 7, NORTH BEACH PLAZA 1 NORTH BEACH ROAD NORTH BEACH, WA 6020 Refer to the disclaimer note on Water Corp E PLAN. CLIENT / S: REF NO: 62093 FILE NO: 13380 DATE: 29.10.13 DRAWN: AC Block located more than 1 kilometre from the ocean. WAHID SIDIQI SURVEYOR SITE INSPECTION REPORT PH: 9448 5009 - FX: 9203 6722 admin@lestersurveys.com.au TITLE DETAILS ELECTRICITY: UNDERGROUND SITE ADDRESS: NOT SIGHTED LOT NOs: 451 C/T VOL: 2633 WATER: YES (not sighted) SIGNED #33 SARASOTA PASS, CLIENT / S Deposited Plan: 48390 220 SEWERAGE: YES, ABOUT 1.1m DEEP (TOP OF RISER) CLARKSON LEGEND ROAD: HOTMIX CITY OF WANNEROO WITNESS Local Authority: STREET LAMP (H) HYDRANT SEMI MOUNTABLE / FLAT KERB: VARIATIONS POWER DOME SHEET No: DWN. DATE (§) STOP VALVE (•) TREE FOOTPATH: CONCRETE (good condition) SIGNED SEWERAGE MANHOLE 1 of 1 PHONE O POWER POLE **BUILDER** VEGETATION: LIGHT GRASS & WEEDS GRATED Communication Pit SEWERAGE MANHOLE SAND & POSSIBLE LIMESTONE AT DEPTH DRAIN JOB No: SIDE ENTRY O DRAINAGE MANHOLE S Sewerage Inspection Lid WITNESS VIEWS: **WATER TAP** 62093 ● TREE STUMP L____ FENCE END REQUIRED REPEG: WATER METER WATER PIPE DATE ☑ PILLAR REPEG TYPE: OLD SURVEY AREA




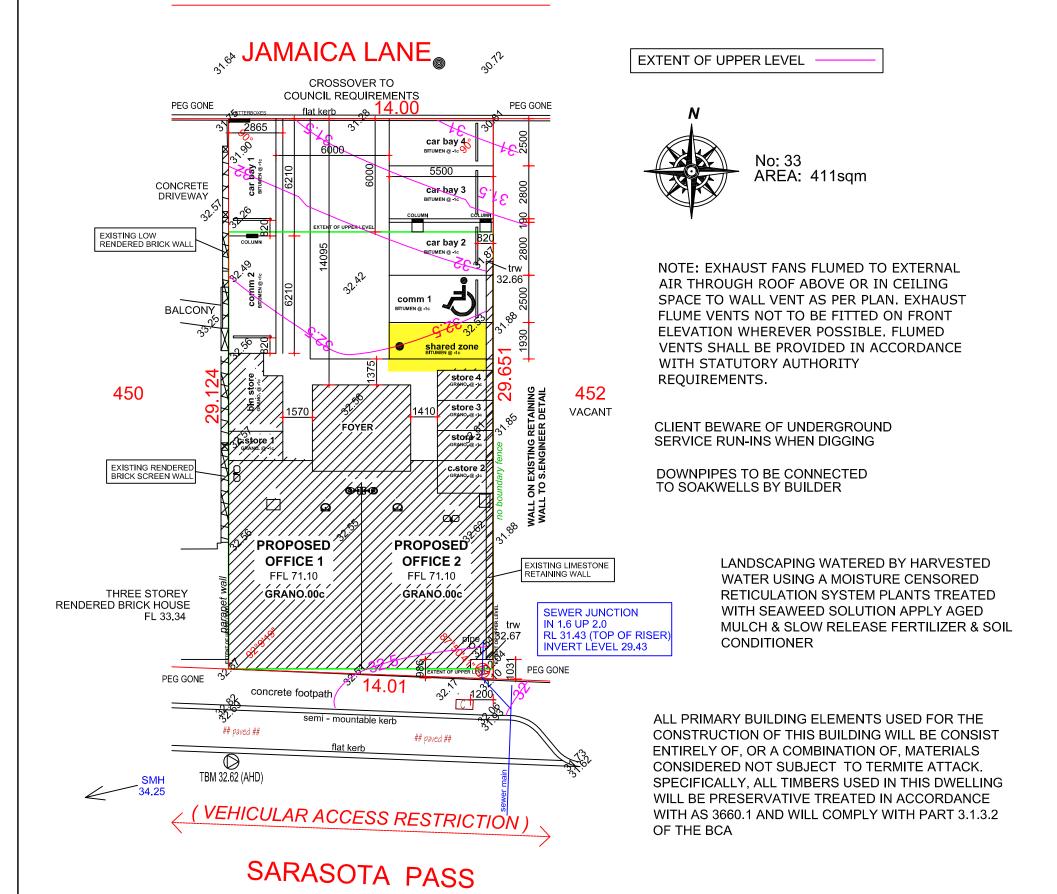

NOTE: SEWER POSITION IS PRELIMINARY BASED ON DESIGN POSITION, AS CONSTRUCTED SEWER POSITION TO BE ADDED WHEN IT BECOMES AVAILABLE FROM WATER CORPORATION



SHADOW CAST AT MIDDAY ON 21 JUNE INDICATED ON PLANE AT 11.0m WITH BE 100% FACING SARASOTA PASS AND WILL NOT AFFECT NEIGHBOURS

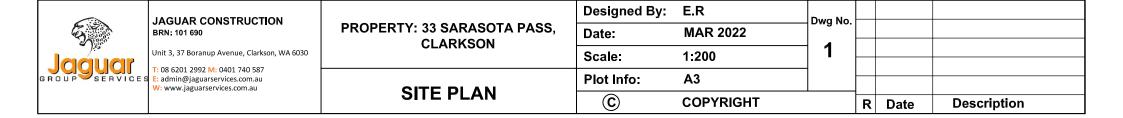



JAMAICA LANE


No: 33 AREA: 411sqm






1X WASTE BIN FOR EACH UNIT & 1X RECYCLING BIN PER UNIT (EXCEPT UNIT 7 & 8 SHARE 1 OF EACH). DIMENSIONED 600MM X 750MM (PER BIN) TO BE TAKEN INDIVIDUALLY TO LANEWAY FOR COLLECTION.

BIN COLLECTION AREA

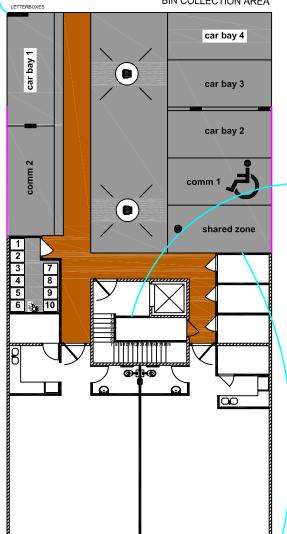

NBN FIBRE TO THE PREMISE READY. FDH **HUB & DISTRUBUTION BOX TO BE LOCATED IN** FOYER. IN ACCORDANCE WITH SERVICE PROVIDER REQUIREMENTS

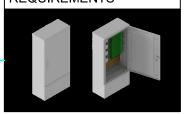


AUTO TIMED LIGHTING FOR PATHWAYS & COMMUNAL OPEN **SPACE & PARKING**




WHEEL STOPS ARE TO BE PROVIDED IN ACCORDANCE WITH AS2890 TO ENSURE VEHICLES DO NOT OVERHANG ANY DESIGNATED PEDESTRIAN PATH OR IMPACT ANY BUILDING (INCLUDING STOREROOM OR GROUND FLOOR DEVELOPMENT).




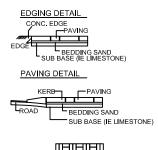

ALL PRIMARY BUILDING ELEMENTS USED FOR THE CONSTRUCTION OF THIS BUILDING WILL BE CONSIST ENTIRELY OF, OR A COMBINATION OF, MATERIALS CONSIDERED NOT SUBJECT TO TERMITE ATTACK. SPECIFICALLY, ALL TIMBERS USED IN THIS DWELLING WILL BE PRESERVATIVE TREATED IN ACCORDANCE WITH AS 3660.1 AND WILL COMPLY WITH PART 3.1.3.2 OF THE BCA

PARTY WALLS HAVE EITHER ACOUSTIC OR FIRE RATING PROPERTIES AND OWNERS ARE RESTRICTED FROM DOING ANYTHING TO THESE WALLS SO AS NOT TO IMPACT THE **WALL PERFORMANCE**

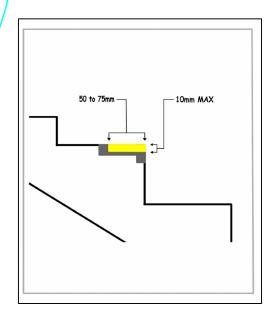

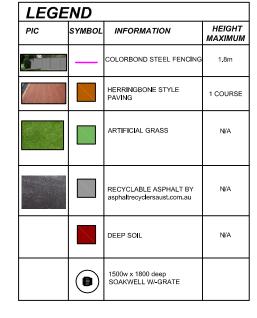

LANDSCAPING WATERED BY **HARVESTED** WATER USING A MOISTURE **CENSORED** RETICULATION SYSTEM **PLANTS** TREATED WITH **SEAWEED** SOLUTION **APPLY AGED** MULCH & SLOW RELEASE FERTILIZER & SOIL CONDITIONER

ELEVATED PLANTER 500mm WIDE BY 1.2m HIGH FILLED WITH DEEP SOIL. TO GET A COLOURFUL SELECTION AND MAXIMUM USAGE OF THE NORTHERN SUN A SELECTION OF THE FOLLOWING PLANTS & SHRUBS WOULD USED.

- GOLDEN BREATH OF HEAVEN (COLEONEMA PULCHELLUM)
- MYRTLE SPURGE (EUPHORBIA MYRSINITES)

PLANTER

SEATING BENCH

TABLE


- NEW ZEALAND SEDGE (CAREX TESTACEA)
- LAVENDER (LAVANDULA STOECHAS)

GROUND FLOOR

3X BIKE RACKS






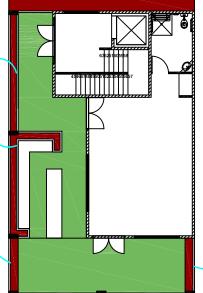

UNIVERSAL DESIGN:


- MANEUVERING IS EASY FOR PRAMS & STROLLERS.
- SHOPS IDEAL FOR WHEELCHAIR ACCESS AND STEP FREE.
- ALL UNITS HAVE LARGE ENTRY DOOR AND NO SMALL CORRIDORS.
- ALL BATHROOM HAVE HOBLESS SHOWERS. • GROUND FLOOR AMBULANT WC.
- WIDE STAIRWAYS AND FOYER




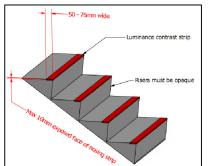

COMMUNAL SPACE ELEVATION



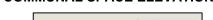

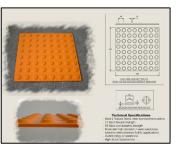

MEZZANINE / COMMUNAL AREA

TACTILE GROUND SURFACE INDICATORS (TGSI) MUST BE PROVIDED TO THE TOP AND BOTTOM OF THE STAIRS IN ACCORDANCE WITH AS 1428.1



JAGUAR CONSTRUCTION


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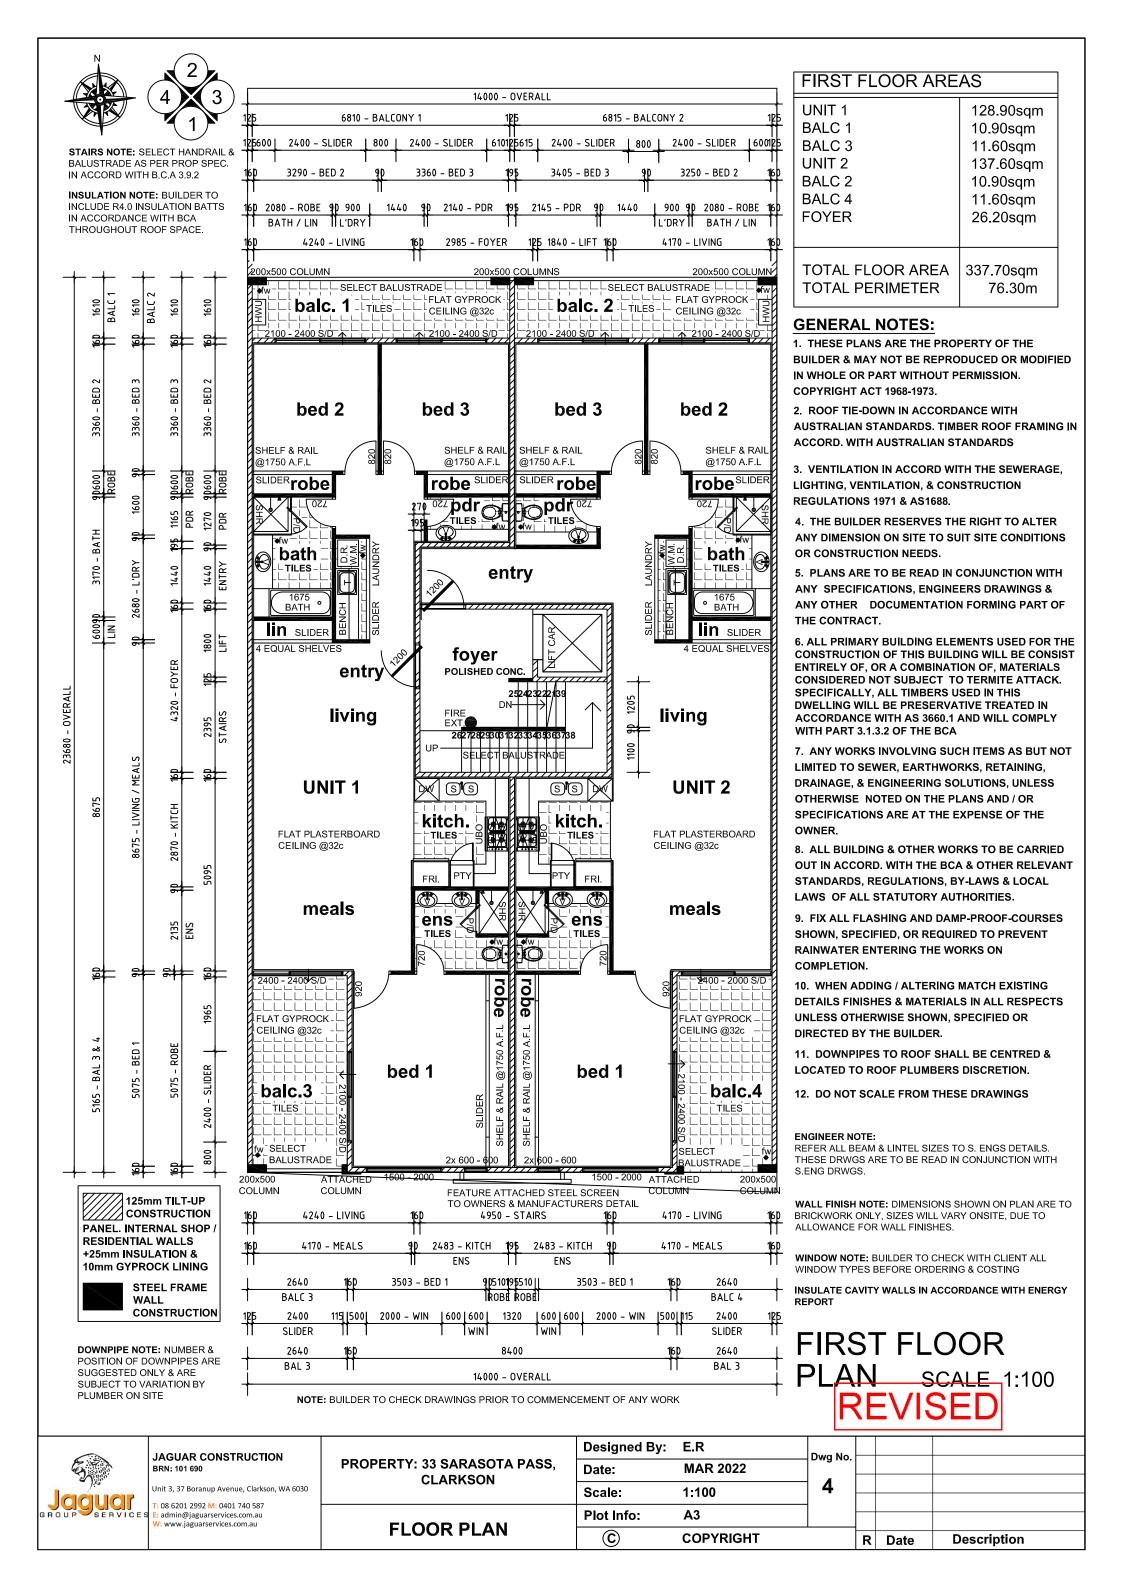
PROPERTY: 33 SARASOTA PASS,


CLARKSON


SITE PLAN

	Designed By:	E.R	Dura Na			
	Date:	MAR 2022	Dwg No.			
	Scale:	1:200	2			
_						
	Plot Info:	A3				
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LOCKERS TO BE PROVIDED FOR EMPLOYEES.

ALL MATERIALS AND BUILDING TO COMPLY WITH 2.11 OF DESIGN GUIDELINES FOR CRIME PREVENTION THROUGH ENVIRONMENTAL

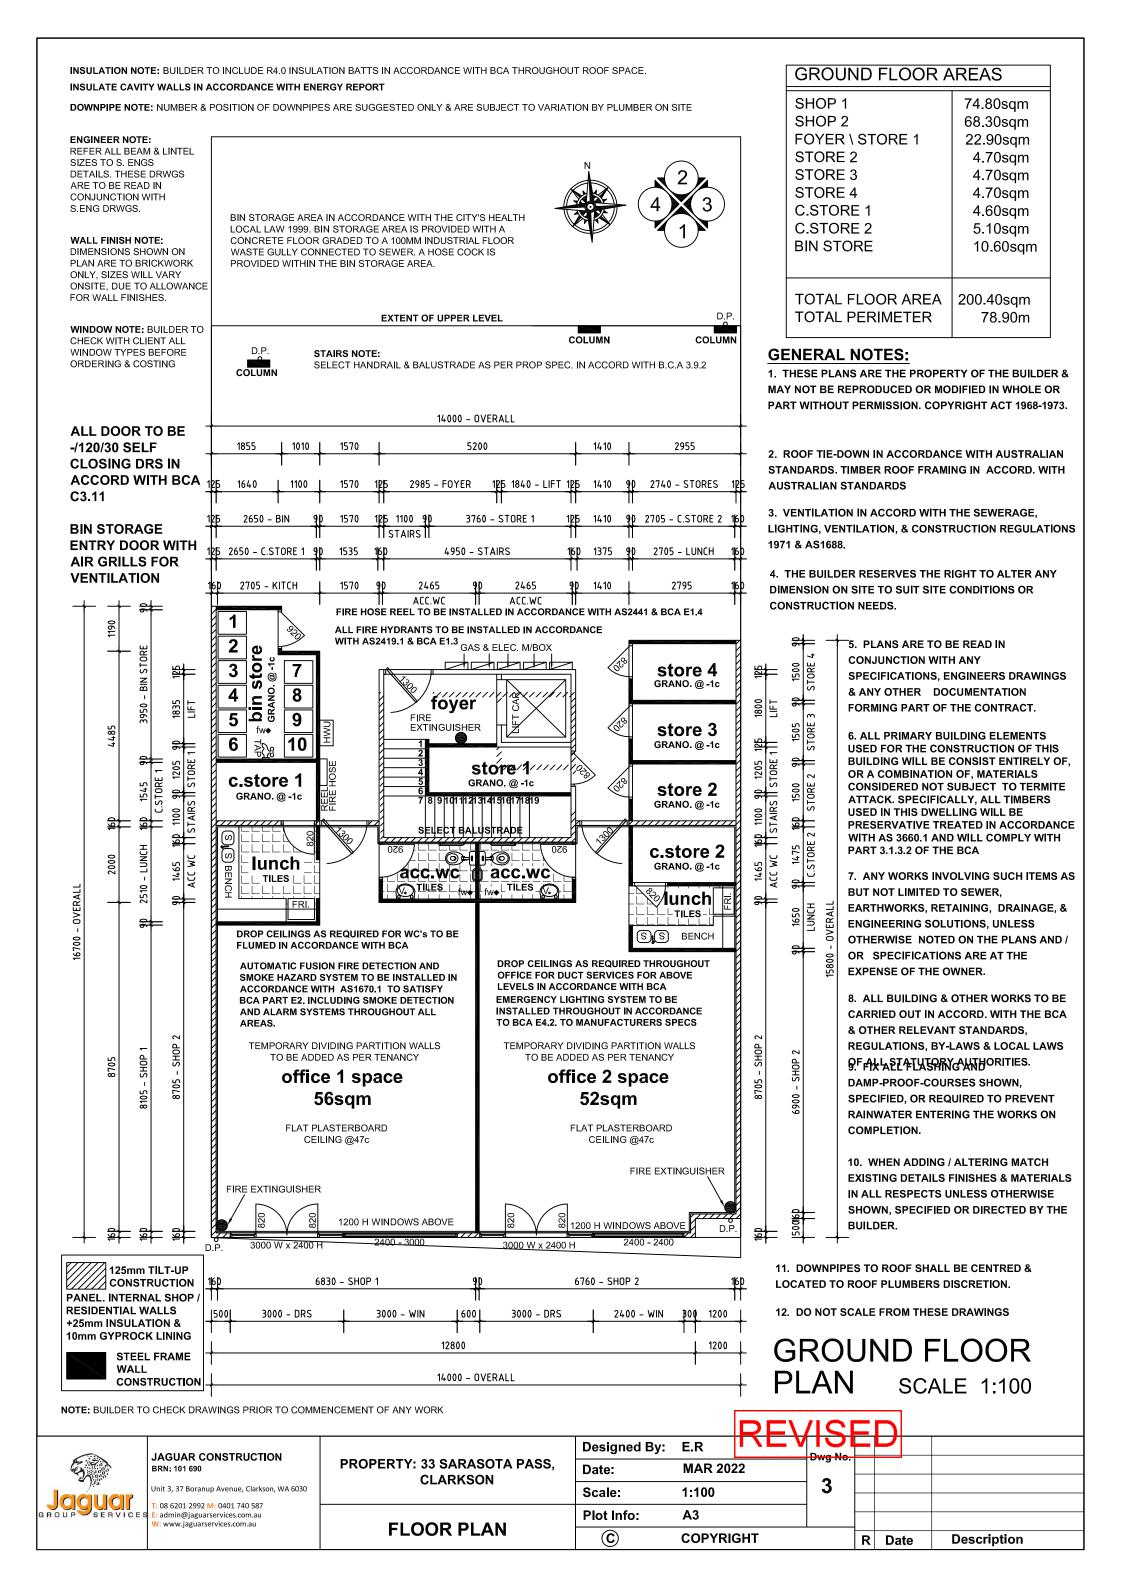
ENGINEER NOTE:

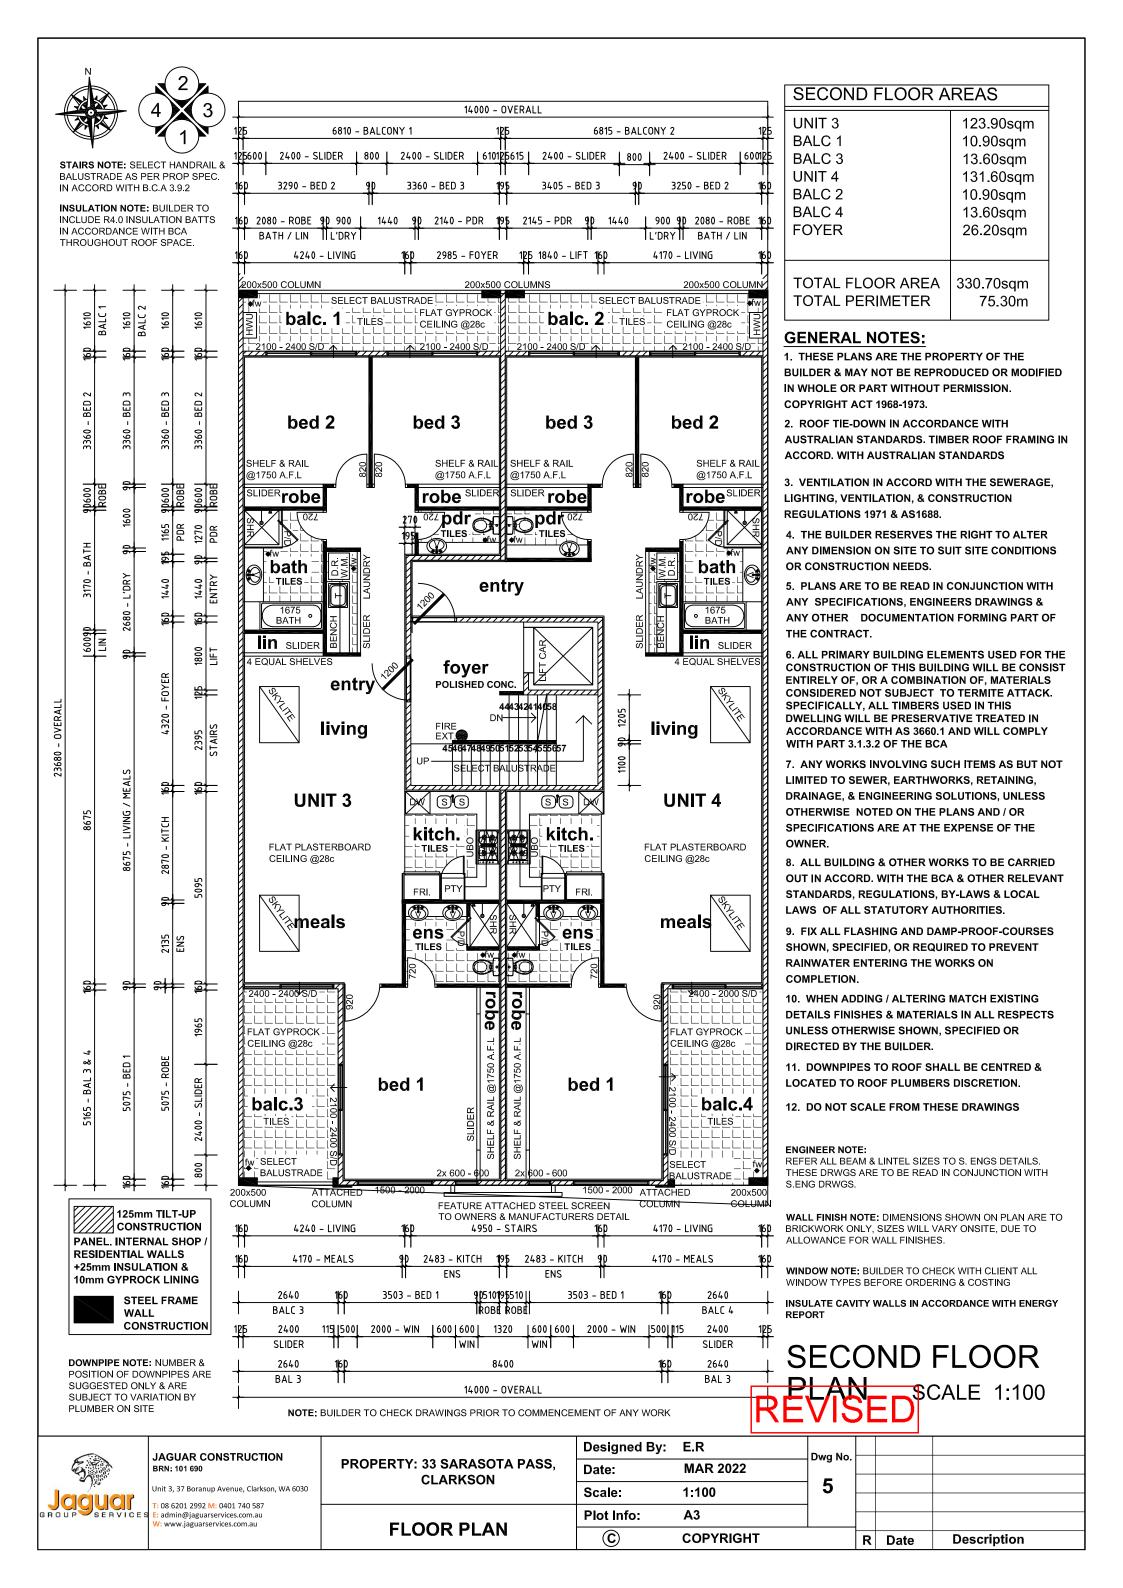REFER ALL BEAM & LINTEL SIZES TO S. ENGS DETAILS. THESE DRWGS ARE TO BE READ IN CONJUNCTION WITH S.ENG DRWGS.

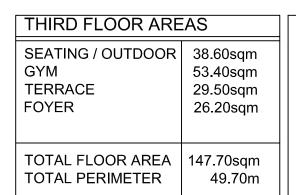WALL FINISH NOTE: DIMENSIONS SHOWN ON PLAN ARE TO BRICKWORK ONLY, SIZES WILL VARY ONSITE, DUE TO ALLOWANCE FOR WALL FINISHES.

WINDOW NOTE: BUILDER TO CHECK WITH CLIENT ALL WINDOW TYPES BEFORE ORDERING & COSTING

INSULATE CAVITY WALLS IN ACCORDANCE

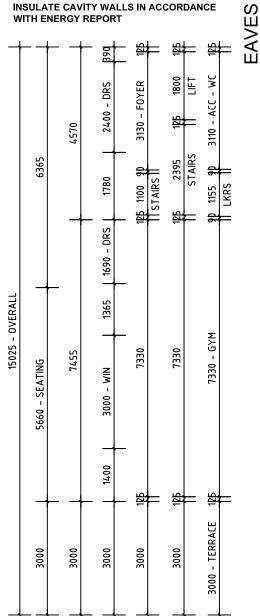


2335 5100 WIN **EAVES GUTTER**

9835 - OVERALL

STAIRS NOTE: SELECT HANDRAIL & BALUSTRADE AS PER PROP SPEC. IN ACCORD WITH B.C.A 3.9.2

INSULATION NOTE: BUILDER TO INCLUDE R4.0 INSULATION BATTS IN ACCORDANCE WITH BCA

THROUGHOUT ROOF SPACE.

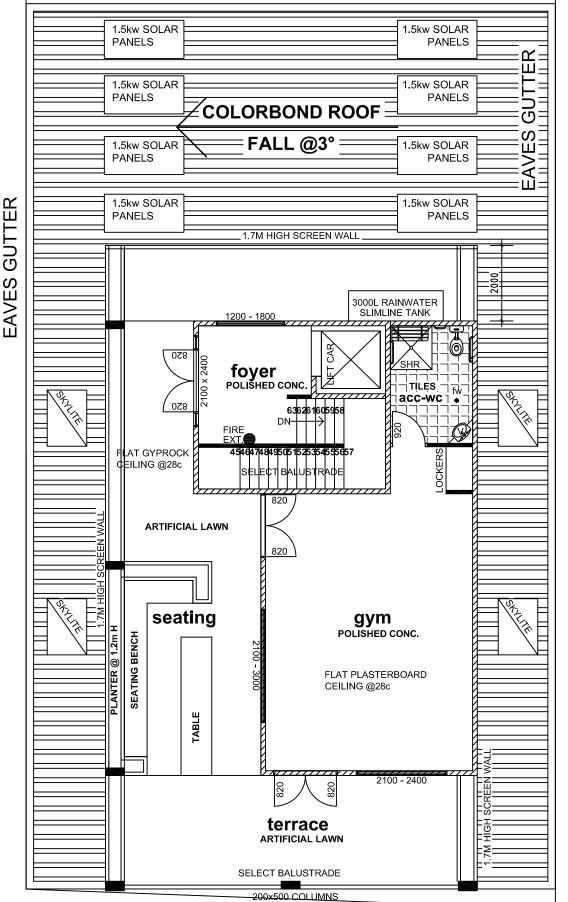

4950 - STAIRS

1690

DRS

9835 - OVERALL / TERRACE





GENERAL NOTES:

- 1. THESE PLANS ARE THE PROPERTY OF THE BUILDER & MAY NOT BE REPRODUCED OR MODIFIED IN WHOLE OR PART WITHOUT PERMISSION. COPYRIGHT ACT 1968-1973.
- 2. ROOF TIE-DOWN IN ACCORDANCE WITH AUSTRALIAN STANDARDS. TIMBER ROOF FRAMING IN ACCORD. WITH AUSTRALIAN STANDARDS
- 3. VENTILATION IN ACCORD WITH THE SEWERAGE, LIGHTING, **VENTILATION, & CONSTRUCTION REGULATIONS 1971 & AS1688.**
- 4. THE BUILDER RESERVES THE **RIGHT TO ALTER ANY DIMENSION** ON SITE TO SUIT SITE CONDITIONS OR CONSTRUCTION NEEDS.
- 5. PLANS ARE TO BE READ IN **CONJUNCTION WITH ANY** SPECIFICATIONS, ENGINEERS **DRAWINGS & ANY OTHER DOCUMENTATION FORMING PART** OF THE CONTRACT.
- 6. ALL PRIMARY BUILDING **ELEMENTS USED FOR THE CONSTRUCTION OF THIS BUILDING** WILL BE CONSIST ENTIRELY OF, OR A COMBINATION OF, MATERIALS CONSIDERED NOT SUBJECT TO TERMITE ATTACK. SPECIFICALLY, **ALL TIMBERS USED IN THIS DWELLING WILL BE PRESERVATIVE** TREATED IN ACCORDANCE WITH AS 3660.1 AND WILL COMPLY WITH PART 3.1.3.2 OF THE BCA
- 7. ANY WORKS INVOLVING SUCH ITEMS AS BUT NOT LIMITED TO SEWER, EARTHWORKS, RETAINING, **DRAINAGE, & ENGINEERING SOLUTIONS, UNLESS OTHERWISE** NOTED ON THE PLANS AND / OR SPECIFICATIONS ARE AT THE EXPENSE OF THE OWNER.
- 8. ALL BUILDING & OTHER WORKS TO BE CARRIED OUT IN ACCORD. WITH THE BCA & OTHER RELEVANT STANDARDS, REGULATIONS, **BY-LAWS & LOCAL LAWS OF ALL** STATUTORY AUTHORITIES.
- 9. FIX ALL FLASHING AND **DAMP-PROOF-COURSES SHOWN,** SPECIFIED, OR REQUIRED TO PREVENT RAINWATER ENTERING THE WORKS ON COMPLETION.
- 10. WHEN ADDING / ALTERING MATCH EXISTING DETAILS FINISHES & MATERIALS IN ALL RESPECTS UNLESS OTHERWISE SHOWN, SPECIFIED OR DIRECTED BY THE BUILDER.
- 11. DOWNPIPES TO ROOF SHALL BE CENTRED & LOCATED TO ROOF PLUMBERS DISCRETION.
- 12. DO NOT SCALE FROM THESE DRAWINGS

125mm TILT-UP **////** CONSTRUCTION PANEL. INTERNAL SHOP / WORK 10mm GYPROCK LINING

> STEEL FRAME WALL CONSTRUCTION

RESIDENTIAL WALLS

+25mm INSULATION &

NOTE: BUILDER TO CHECK DRAWINGS PRIOR TO COMMENCEMENT OF ANY

LOCKERS TO BE PROVIDED FOR EMPLOYEES.

ALL MATERIALS AND BUILDING TO COMPLY WITH 2.11 OF **DESIGN GUIDELINES FOR** CRIME PREVENTION THROUGH ENVIRONMENTAL DESIGN.

DOWNPIPE NOTE: NUMBER & POSITION OF DOWNPIPES ARE SUGGESTED ONLY & ARE SUBJECT TO VARIATION BY PLUMBER





JAGUAR CONSTRUCTION

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PROPERTY: 33 SARASOTA PASS.

1100

| 900 |

810

4110 - SEATING

CLARKSON FLOOR PLAN

Designed By:	E.R	Dwg No.			
Date:	MAR 2022				
Scale:	1:100	6			
Plot Info:	A3				
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ACC-WC

1475

2400 - WIN

5475 - GYM


5725


15001

| 7001<u>P</u>5

lkrsll


| 800 |

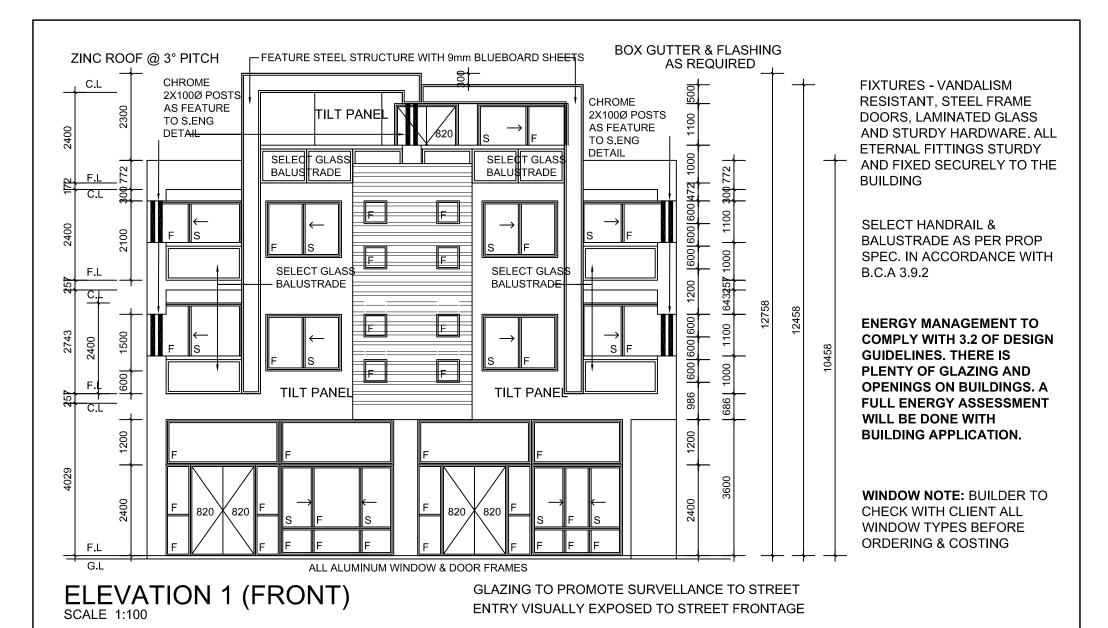

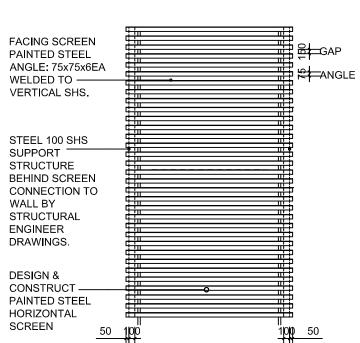

SCREEN DETAILS (FRONT)



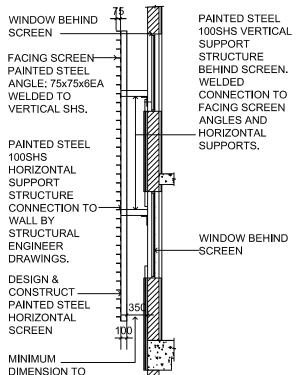


ENGINEER NOTE: REFER ALL BEAM & LINTEL SIZES TO S. ENGS DETAILS. THESE DRWGS ARE TO BE READ IN CONJUNCTION WITH S.ENG DRWGS.

THE HEIGHT AND TYPE OF BALUSTRADE FOR BALCONIES IS IN COMPLIANCE WITH BCA 3.8.2

ALL AWNING WINDOWS ARE OPENABLE AT MAXIMUM 125mm. OTHER UPPER BEDROOM HABITABLE ROOM HAVE SCREENING 1.7m ABOVE F.L WERE NEEDED


ALL OTHER PROTECTION OF OPENABLE WINDOWS ON THE UPPER FLOOR BEDROOMS HAS BEEN ADDRESSED AND COMPLY WITH BCA 3.8.2.5

SCREEN DETAILS (SIDE)

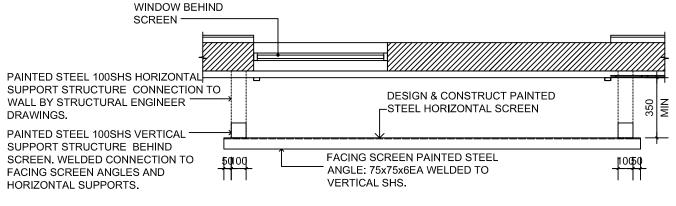



FACE OF BRICK

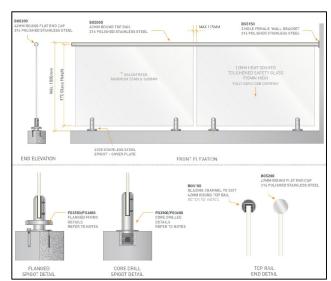


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GROUPSERVICE	9 E:

IAGUAR CONSTRUCTION BRN: 101 690

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PROPERTY: 33 SARASOTA PASS, **CLARKSON**

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Scale:	1:100	7			
Plot Info:	A3				
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COLOUR & MATERIALS FRONT ELEVATION

BOX GUTTER

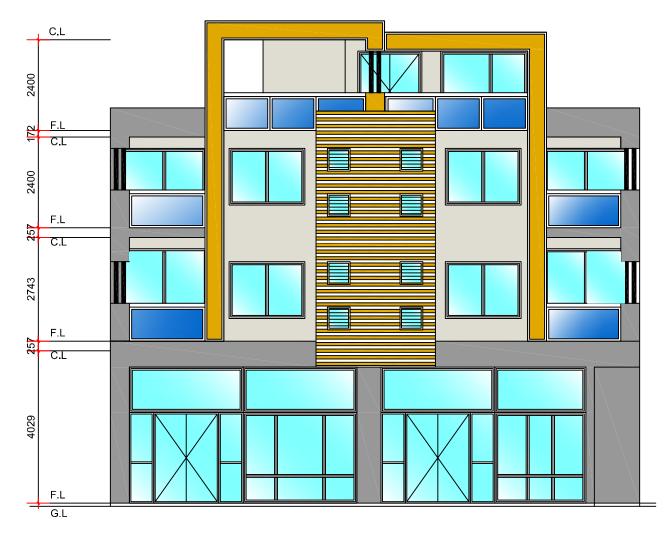AND FLASHING AS REQUIRED ZINC ROOF @ 3° PITCH C.L TILT PANEL 1.7M OBSCURE GLAZED 2100 SCREENING 009 **TILT PANEL** F.Lc C.L. 2400 2100 SELECT GLASS BALUSTRADE SELECT GLASS BALUSTRADE 25 C L C 2743 2100 SELECT GLASS BALUSTRADE SELECT GLASS BALUSTRADE F.L. 989 ALL ALUMINUM WINDOW & DOOR FRAMES C.L. 3600 3600 1300 1300 1300 F.L G.L COLUMNS TO S.ENG DETAIL INDIVIDUAL GAS & ELECTRICAL M/BOXES FOR UNITS **COLUMN TO** S.ENG DETAIL

ELEVATION 2 (REAR) SCALE 1:100

ENGINEER NOTE: REFER ALL BEAM & LINTEL SIZES TO S. ENGS DETAILS. THESE DRWGS ARE TO BE READ IN CONJUNCTION WITH S.ENG DRWGS.

SELECT HANDRAIL & BALUSTRADE AS PER PROP SPEC. IN ACCORDANCE WITH B.C.A 3.9.2


ENERGY MANAGEMENT TO COMPLY WITH 3.2 OF DESIGN GUIDELINES. THERE IS PLENTY OF GLAZING AND OPENINGS ON BUILDINGS. A FULL ENERGY ASSESSMENT WILL BE DONE WITH BUILDING APPLICATION.




FEATURE SCREEN
(POSSIBLE CEDAR
COLOUR) TO ATTRACT
ATTENTION & FOR
VISUAL AESTHETICS



TILT UP PANEL WITH CLEAR FINISH SHOWN GREY

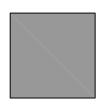

TILT UP PANEL WITH DARK GREY FINISH

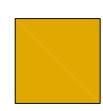

COLOURED
(POSSIBLE DARK
CREAM) TO
ATTRACT
ATTENTION & FOR
VISUAL AESTHETICS

STREET SURVEILLANCE: LARGE WINDOWS ARE PROVIDED FACING MAIN STREETS. SECURITY CAMERAS AND SENSORS WOULD ALSO BE PROVIDED AT OWNERS DISCRETION.


THE HEIGHT AND TYPE OF BALUSTRADE FOR BALCONIES IS IN COMPLIANCE WITH BCA 3.8.2

ALL AWNING WINDOWS ARE OPENABLE AT MAXIMUM 125mm. OTHER UPPER BEDROOM HABITABLE ROOM HAVE SCREENING 1.7m ABOVE F.L WERE NEEDED

ALL OTHER PROTECTION OF OPENABLE WINDOWS ON THE UPPER FLOOR BEDROOMS HAS BEEN ADDRESSED AND COMPLY WITH BCA 3.8.2.5

FIXTURES - VANDALISM RESISTANT, STEEL FRAME DOORS, LAMINATED GLASS AND STURDY HARDWARE. ALL ETERNAL FITTINGS STURDY AND FIXED SECURELY TO THE BUILDING

WINDOW NOTE: BUILDER TO CHECK WITH CLIENT ALL WINDOW TYPES BEFORE ORDERING & COSTING

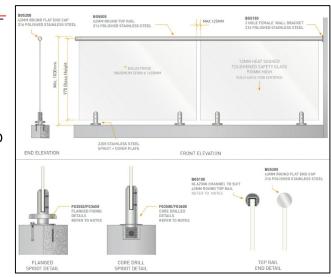



JAGUAR CONSTRUCTION BRN: 101 690


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PROPERTY: 33 SARASOTA PASS, CLARKSON


ELEVATIONS

Designed By:	E.R	Dwa N		
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Scale:	1:100		8	
Plot Info:	A3			
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	R	Date	Description
8			
Dwg No.			
D N			



ELEVATION 3 (SIDE) SCALE 1:100

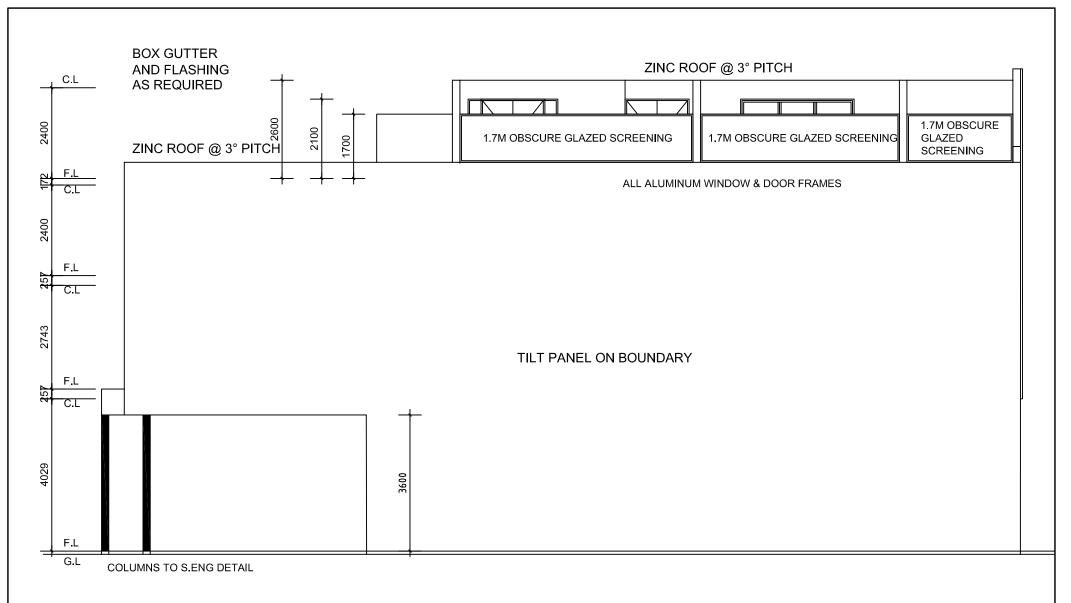

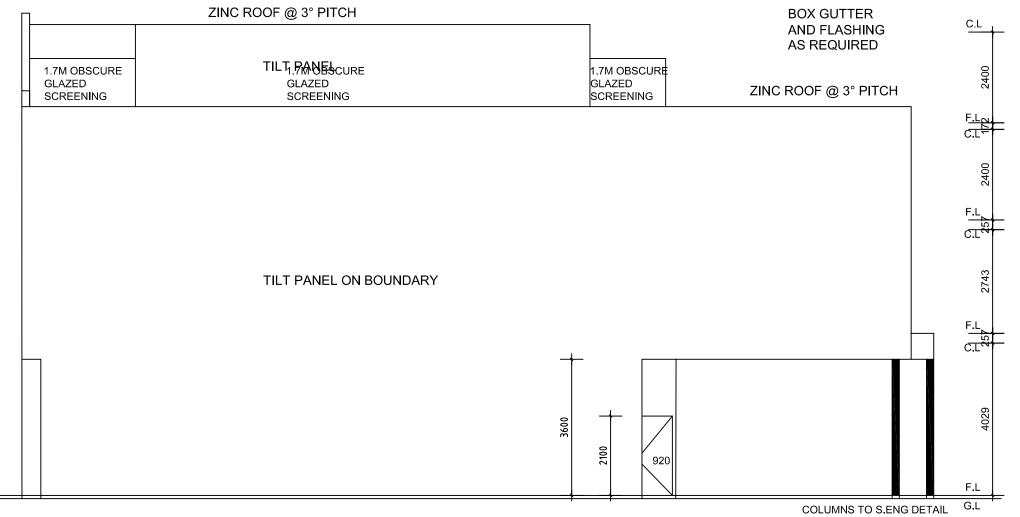ELEVATION 3 (SIDE)

ENGINEER NOTE: REFER ALL BEAM & LINTEL SIZES TO S. ENGS DETAILS. THESE DRWGS ARE TO BE READ IN CONJUNCTION WITH S.ENG DRWGS.

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FIXTURES - VANDALISM RESISTANT, STEEL FRAME DOORS, LAMINATED GLASS AND STURDY HARDWARE. ALL ETERNAL FITTINGS STURDY AND FIXED

REVISED

SECURELY TO THE BUILDING


	JAGUAR CONSTRUCTION		Designed By:	E.R	Dwg No.			
5	BRN: 101 690	PROPERTY: 33 SARASOTA PASS, CLARKSON	Date:	MAR 2022	Dwg No.			
	Unit 3, 37 Boranup Avenue, Clarkson, WA 6030	CLARRSON	Scale: 1:100	1:100	[†] 9			
GROUPSERVICE	T: 08 6201 2992 M: 0401 740 587 E: admin@jaguarservices.com.au W: www.jaguarservices.com.au	ELEVATIONS	Plot Info:	A3				
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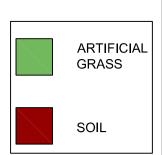


LOW MAINTENANCE FOXTAIL AGAVE (AGAVE ATTENUATA)

REVISED


1 7M HIGH SCREEN




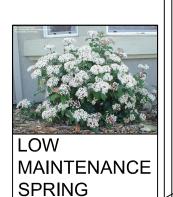


LAURUSTINUS

BOUQUET

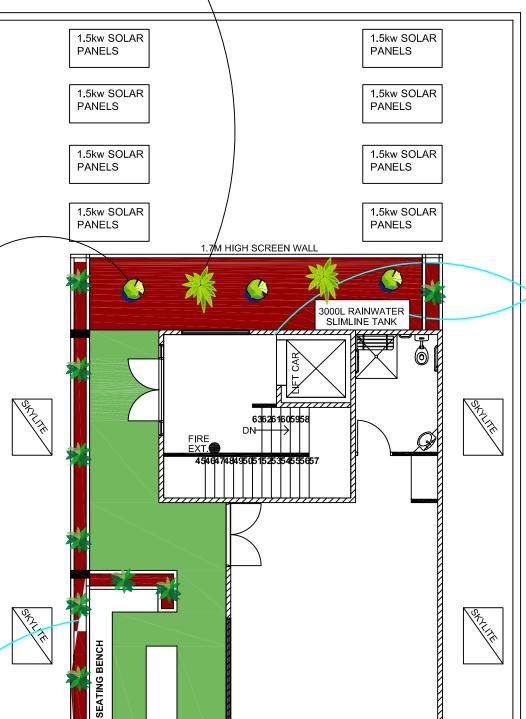

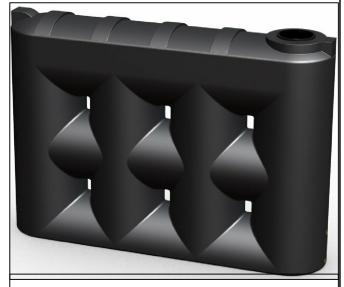

3000L RAINWATER SLIMLINE TANK

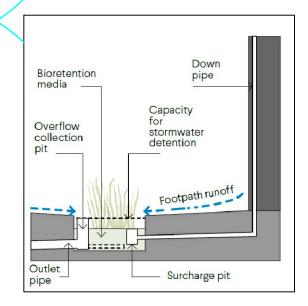

GROUND COVER SHRUBS HERMIANDRA PUNGENS. IDEAL FOR LANDSCAPING STRIP.



ELEVATED PLANTER 500mm WIDE BY 1.2m HIGH FILLED WITH DEEP SOIL. TO GET A COLOURFUL SELECTION AND MAXIMUM USAGE OF THE NORTHERN SUN A SELECTION OF THE FOLLOWING PLANTS & SHRUBS WOULD USED.

- GOLDEN BREATH OF HEAVEN (COLEONEMA PULCHELLUM)
- MYRTLE SPURGE (EUPHORBIA MYRSINITES)
- NEW ZEALAND SEDGE (CAREX TESTACEA)
- LAVENDER (LAVANDULA STOECHAS)



LANDSCAPE PLAN



JAGUAR CONSTRUCTION
BRN: 101 690

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LANDSCAPING

E.R	Dwg No			
MAR 2022	Dwg No.			
Scale: 1:100				
	1			
A0				
COPYRIGHT		R	Date	Description
	MAR 2022 1:100 A3	MAR 2022 1:100 A3	MAR 2022 1:100 A3	MAR 2022 1:100 A3 Dwg No. 25