
IMPORTANT NOTES:

- The boundary information on this site plan is approximate only. The boundary has been positioned using a best-fit of available existing site plan.
- A re-peg/b'dry identification survey is recommended if an accurate position of features / improvements relative to the boundary is required
- The lot dimensions shown on this feature survey plan have been taken from L.T.O survey plan. The final re-pegged dimensions may vary due to adjustments made during field survey

All service information shown on this plan should be verified with the relevant authorities.

- does not accept any liability for any loss or damage caused by the use of this feature survey plan for any purpose.
- No up-to-date drawings were available during completion of drawings (including site plan, floor plans, elevations etc.)
- All information noted on current site plan has been taken from previous site plan provided by clients. does not accept any liability for incorrect dimensions/final positioning of structures.
- No sewer or hydraulic information was available during time of site plan. Client/builder is to check on site and contact Water Corp. prior to any construction. All dimensions to be checked and confirmed on site prior to any commencement of construction work.
- A site feature survey is recommended for the correct positioning of all site features and existing dwellings
- k) All heights and levels shown on drawings are based of existing RL's as per existing site plan document. Further RL's have been manually calculated and measured on site to ensure elevations are
- Final dimensions, heights, and locations of features may vary on site as per Contractor's discretion. If any changes or amendments are required, then a revised working drawing set is to be completed and forwarded to all relevant stakeholders

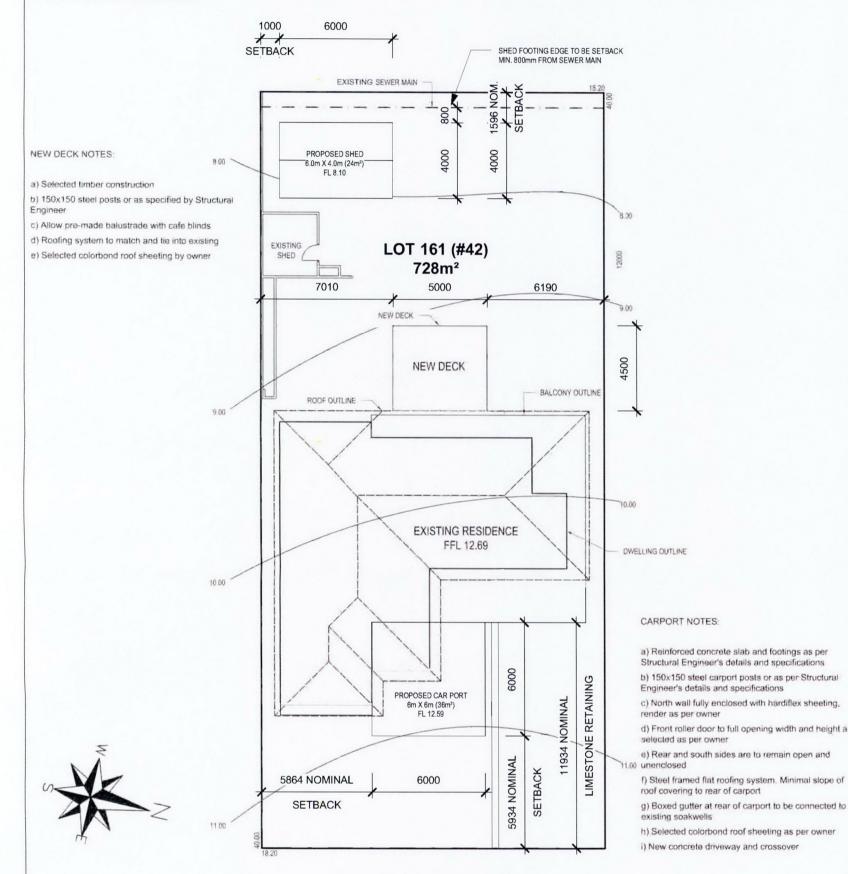

YALLAMBEE CRESCENT

SITE WORKS TO INCLUDE BUT NOT LIMITED TO:

- 1. REMOVAL OF TREES, SHRUBS & LAWN.
- 2. SOAKWELLS TO SHIRE REQUIREMENTS
- 3. CLOSE OFF EXISTING RETICULATION PRIOR TO CONSTRUCTION.


DOWNPIPES AND SOAKWELLS LOCATION TO BE CONFIRMED BY BUILDER. ALL DOWNPIPES CONNECTED TO SOAKWELLS WITH STORMWATER PIPES BY BUILDER.

STORMWATER DISPOSAL TO COUNCIL REQUIREMENTS. SOAKWELL TO HAVE TRAFFICABLE LIDS AND ARE POSITIONED AT THE PLUMBERS DISCRETION

GENERAL NOTES

- 1. VENTILATION IN ACCORD WITH THE SEWERAGE, LIGHTING, VENTILATION, & CONSTRUCTION REGULATIONS 1971 & AS1688.
- 2. ALL PRIMARY BUILDING ELEMENTS USED FOR THE CONSTRUCTION OF THIS BUILDING WILL BE CONSIST ENTIRELY OF, OR A COMBINATION OF, MATERIALS CONSIDERED NOT SUBJECT TO TERMITE ATTACK. SPECIFICALLY, ALL TIMBERS (IF ANY) USED IN THIS DWELLING WILL BE PRESERVATIVE TREATED IN ACCORDANCE WITH AS 3660.1 AND WILL COMPLY WITH PART 3.1.3.2 OF
- 3. IT IS THE BUILDER'S RESPONSIBILITY TO COMPLY WITH ALL STATUTORY AUTHORITY REGULATIONS AND REQUIREMENTS WHICH IN THE EVENT OF ANY DISCREPANCY SHALL TAKE
- 5. BUILDER MUST CHECK CONFIRM ON SITE ALL DIMENSIONS IN ACCORDANCE WITH THESE
- 6. PLANS ARE TO BE READ IN CONJUNCTION WITH ANY SPECIFICATIONS, STRUCTURAL ENGINEER'S DRAWINGS & ANY OTHER DOCUMENTATION FORMING PART OF THE PROJECT.
- PROOF-COURSES AS REQUIRED TO PREVENT RAINWATER ENTERING THE WORKS ON
- 8. ALL BUILDING & OTHER WORKS TO BE CARRIED OUT IN ACCORDANCE WITH NATIONAL CONSTRUCTION CODE (NCC) & OTHER RELEVANT STANDARDS, REGULATIONS, BY-LAWS & LOCAL LAWS OF ALL STATUTORY AUTHORITIES.
- SLAB AND / OR FOOTINGS.
- 10. REFER TO GEOTECH REPORT FOR SOIL & WIND
- 11. ANY DISCREPANCIES TO BE NOTIFED TO STRUCTURAL ENGINEER PRIOR TO WORK



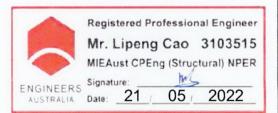

FOR INFORMATION ONLY

*THIS DRAWING IS TO BE USED ONLY FOR COUNCIL APPROVAL APPLICATION

DRAWING No. A000 Drawing Title REV No. SCALE: 1:200 SHEET SIZE: A3 SITE PLAN PROPOSED NEW ADDITION TO EXISTING P.A.I.D Development Ptv Ltd **DWELLING ON LOT 161, #42 YALLAMBEE CRESCENT, WANNEROO WA** Address: PO Box 425 Leederville, Western Australia 6902 19/05/2022 ISSUED FOR COUNCIL APPROVAL ww.paid group.com 19/05/2022

THE BCA

PRECEDENCE OVER THESE DRAWINGS

4. BUILDER TO CHECK DRAWINGS PRIOR TO COMMENCEMENT OF ANY WORK.

PLANS . DO NOT SCALE FROM DRAWINGS.

7. BUILDER TO FIX ALL FLASHING AND DAMP-


9. DRAINAGE REQUIREMENTS (SUBSOIL, SOAKWELLS, RUNOFF AND STORMWATER) ARE TO BE DETERMINED ON SITE. ENSURE THERE IS NO DISCHARGE OR POOLING OF WATER AGAINST THE

CLASSIFICATION.

COMMENCING.


a) All information as shown on floor plans are based on existing plans provided by clients. All information and details shown are diagrammatic only and is subject to differ on site.


b) All dimensions as shown on floor plans are to be checked and confirmed on site prior to any construction work commencing. Building Designer accept no liability or responsibility for inaccuracies in dimensions.
 c) Final positioning of all fixtures and fittings are subject to differ on site as per owner, contractor or licensed plumber discretion. No sewer or hydraulic services layouts were available at time of producing

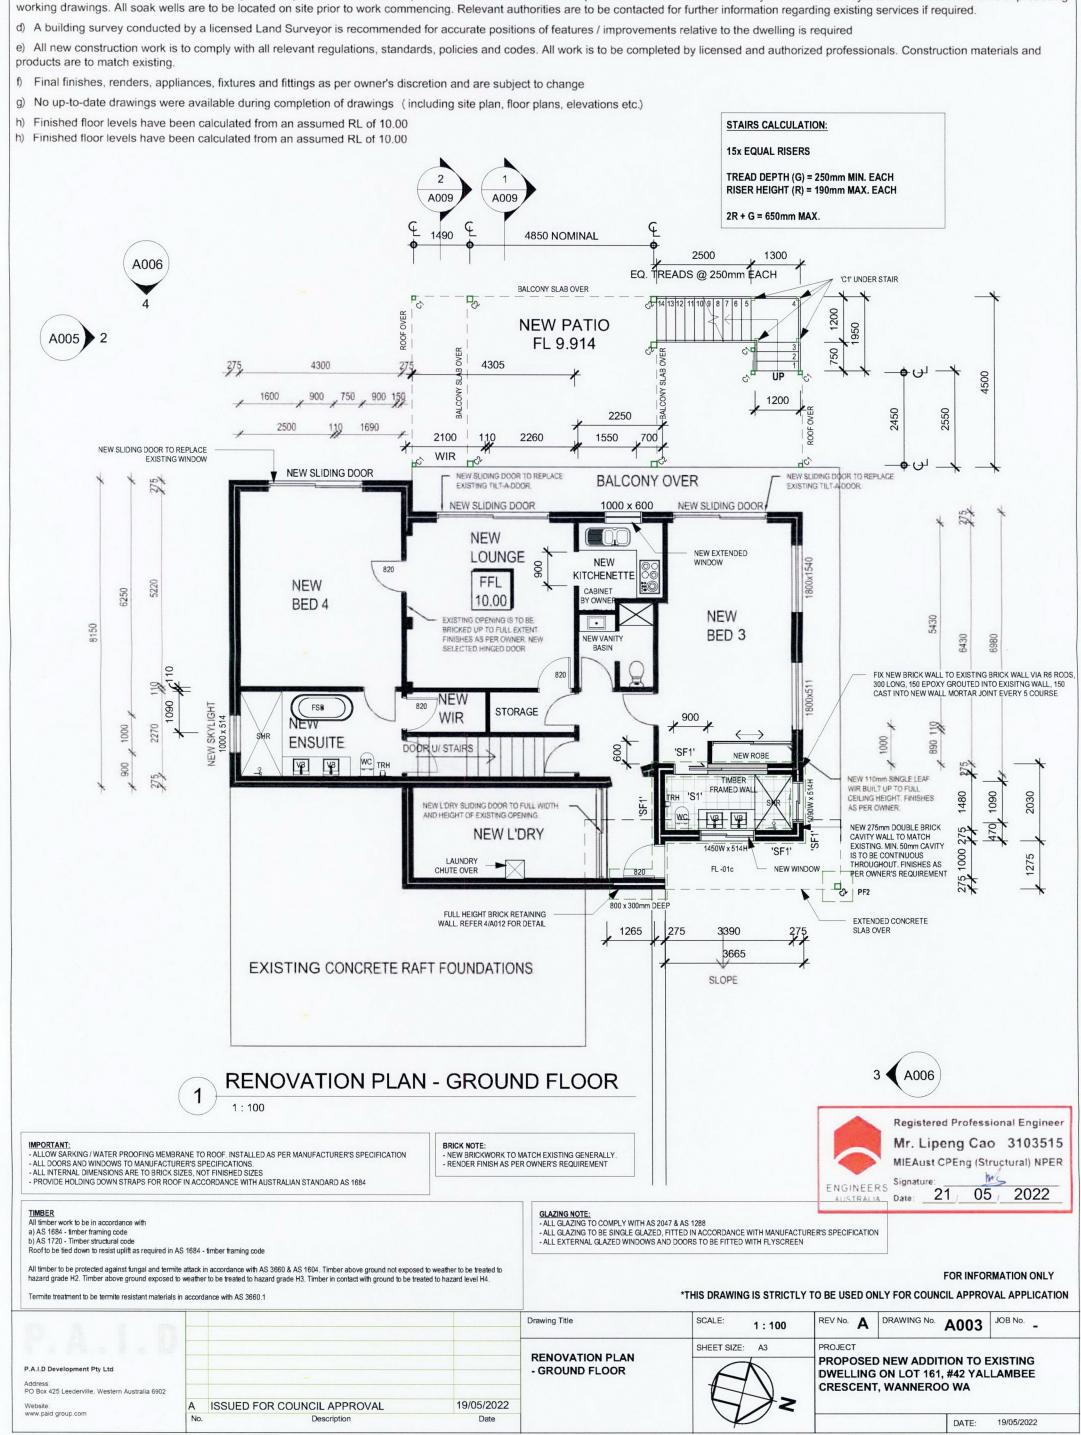


IMPORTANT NOTES:

- All information as shown on floor plans are based on existing plans provided by clients. All information and details shown are diagrammatic only and is subject to differ on site
- b) All dimensions as shown on floor plans are to be checked and confirmed on site prior to any construction work commencing. Building Designer accept no liability or responsibility for inaccuracies in dimensions
- c) Final positioning of all fixtures and fittings are subject to differ on site as per owner, contractor or licensed plumber discretion. No sewer or hydraulic services layouts were available at time of producing working drawings. All soak wells are to be located on site prior to work commencing. Relevant authorities are to be contacted for further information regarding existing services if required.
- d) A building survey conducted by a licensed Land Surveyor is recommended for accurate positions of features / improvements relative to the dwelling is required
- e) All new construction work is to comply with all relevant regulations, standards, policies and codes. All work is to be completed by licensed and authorized professionals. Construction materials and products are to match existing.
- f) Final finishes, renders, appliances, fixtures and fittings as per owner's discretion and are subject to change
- No up-to-date drawings were available during completion of drawings (including site plan, floor plans, elevations etc.)

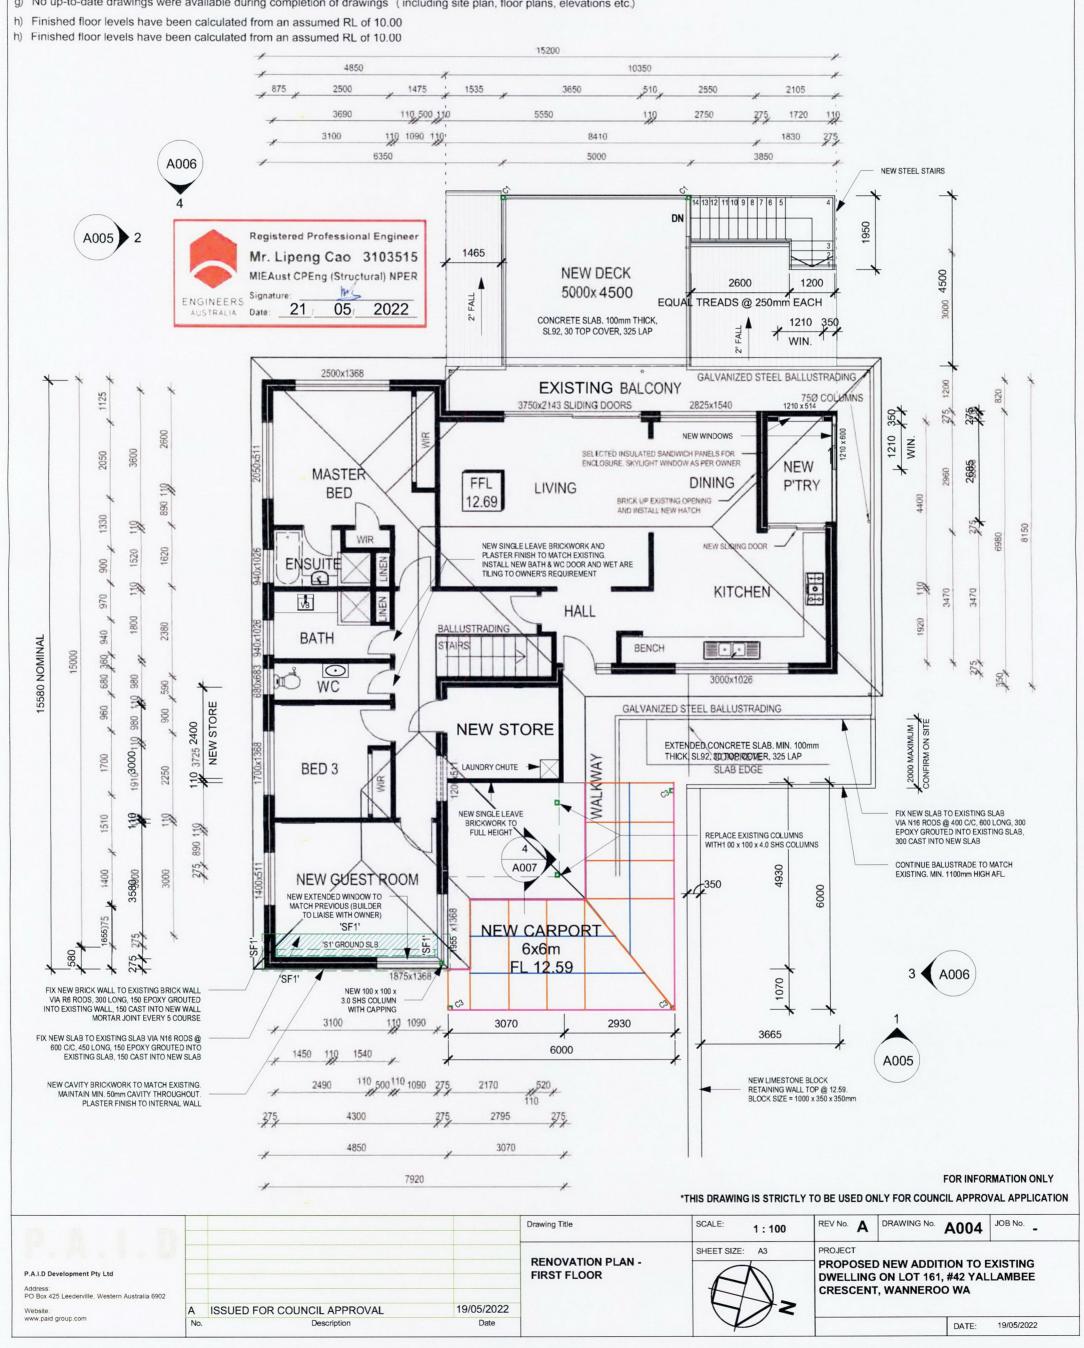

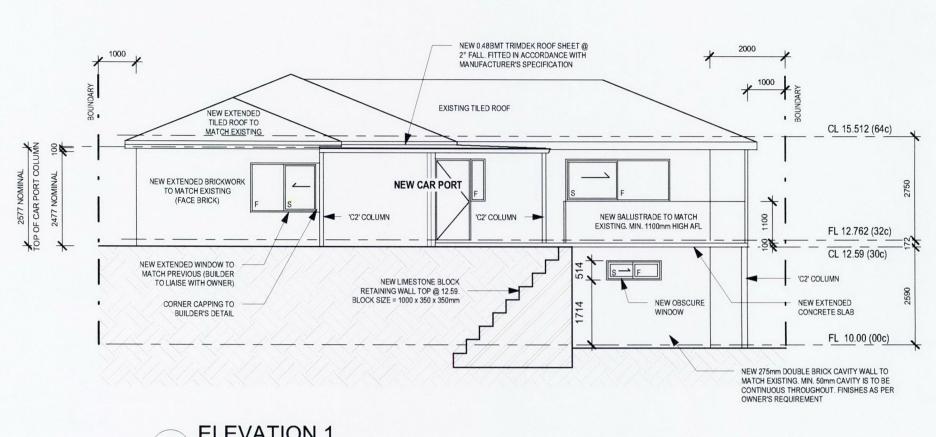

ELEVATION 1 1:100

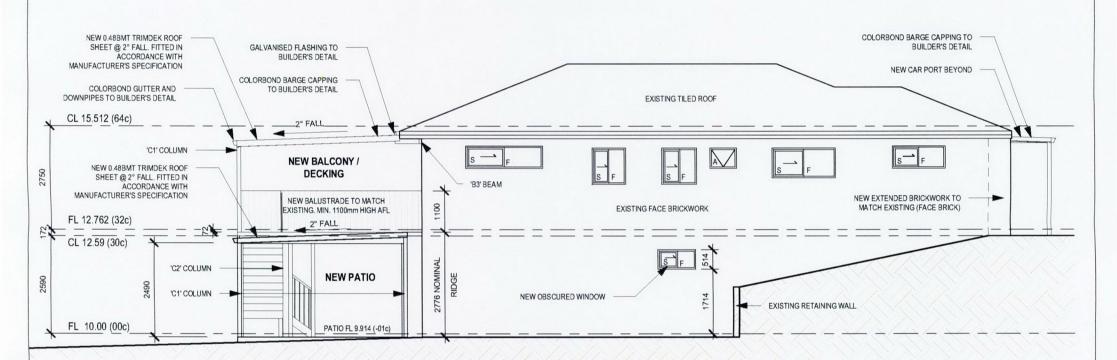





IMPORTANT:
- ALLOW SARKING / WATER PROOFING MEMBRANE TO ROOF, INSTALLED AS PER MANUFACTURER'S SPECIFICATION
- ALL DOORS AND WINDOWS TO MANUFACTURER'S SPECIFICATIONS.

- ALL INTERNAL DIMENSIONS ARE TO BRICK SIZES, NOT FINISHED SIZES - PROVIDE HOLDING DOWN STRAPS FOR ROOF IN ACCORDANCE WITH AUSTRALIAN STANDARD AS 1684

GLAZING NOTE:
- ALL GLAZING TO COMPLY WITH AS 2047 & AS 1288

NEW BRICKWORK TO MATCH EXISTING GENERALLY.
 RENDER FINISH TO OWNER'S REQUIREMENT

- ALL GLAZING TO BE SINGLE GLAZED, FITTED IN ACCORDANCE WITH MANUFACTURER'S SPECIFICATION - ALL EXTERNAL GLAZED WINDOWS AND DOORS TO BE FITTED WITH FLYSCREEN

TIMBER

All timber work to be in accordance with a) AS 1684 - timber framing code
 b) AS 1720 - Timber structural code

Roof to be tied down to resist uplift as required in AS 1684 - timber framing code

All timber to be protected against fungal and termite attack in accordance with AS 3660 & AS 1604. Timber above ground not exposed to weather to be treated to

hazard grade H2. Timber above ground exposed to weather to be treated to hazard grade H3. Timber in contact with ground to be treated to hazard level H4.

Termite treatment to be termite resistant materials in accordance with AS 3660.1

- ALL WORK TO BE COMPLETED IN ACCORDANCE TO NATIONAL CONSTRUCTION CODE (NCC) AND AUSTRALIAN STANDARDS BY A FULLY LICENCED /
- IT IS THE BUILDERS RESPONSIBILITY TO COMPLY WITH ALL STATUTORY AUTHORITY REGULATIONS AND REQUIREMENTS WHICH IN THE EVENT OF ANY DISCREPANCY SHALL TAKE PRECEDENCE OVER THESE DRAWINGS
- BUILDER TO CHECK DRAWINGS PRIOR TO COMMENCEMENT OF ANY WORK, BUILDER MUST CHECK CONFIRM ON SITE ALL DIMENSIONS IN ACCORDANCE WITH THESE PLANS. DO NOT SCALE FROM DRAWINGS.
- THIS DRAWING MUST BE READ IN CONJUNCTION WITH ENERGY EFFICIENCY REPORT AND ANY OTHER RELEVANT CONSULTANTS DRAWINGS.
- KITCHEN LAYOUT AND FIXTURES SHOWN ARE INDICATIVE ONLY FOR THE PURPOSE OF PRESENTATION. CLIENT TO LIAISE WITH SUB-CONTRACTOR FOR FINAL LAYOUT

WET AREA NOTES:

DIMENSION NOTE:
- DIMENSIONS SHOWN ON PLAN ARE NOMINAL ONLY, SIZES WILL VARY ONSITE, DUE TO ALLOWANCE FOR WALL FINISHES. INSULATION NOTE:
- INSTALL SARKING UNDER ROOF SHEET AND BATTS INSULATION THROUGHOUT CEILING SPACE IN ACCORDANCE WITH BCA, NCC. AND ENERGY EFFICIENCY


REQUIREMENTS.


- WATERPROOFING TO WET AREAS AND EXTERNAL WALLS IN ACCORDANCE WITH AS3740 & NCC REQUIREMENTS.
- TILED UPTURN MIN. 300mm ABOVE FINISH FLOOR LEVEL TO ALL WET AREAS
- LOCATION OF FLOOR WASTES TO WET AREAS TO BE DETERMINED BY PLUMBER. ALL PLUMBING PENETRATIONS TO BE FULLY WATERPROOF SEALED TO


FOR INFORMATION ONLY


*THIS DRAWING IS STRICTLY TO BE USED ONLY FOR COUNCIL APPROVAL APPLICATION

DRAWING No. A005 REV No. JOB No. Drawing Title SCALE: 1:100 SHEET SIZE: A3 **PROJECT ELEVATION 1 AND 2** PROPOSED NEW ADDITION TO EXISTING P.A.I.D Development Pty Ltd **DWELLING ON LOT 161, #42 YALLAMBEE CRESCENT, WANNEROO WA** Address: PO Box 425 Leederville, Western Australia 6902 ISSUED FOR COUNCIL APPROVAL 19/05/2022 Website: www.paid group.com Description Date DATE:

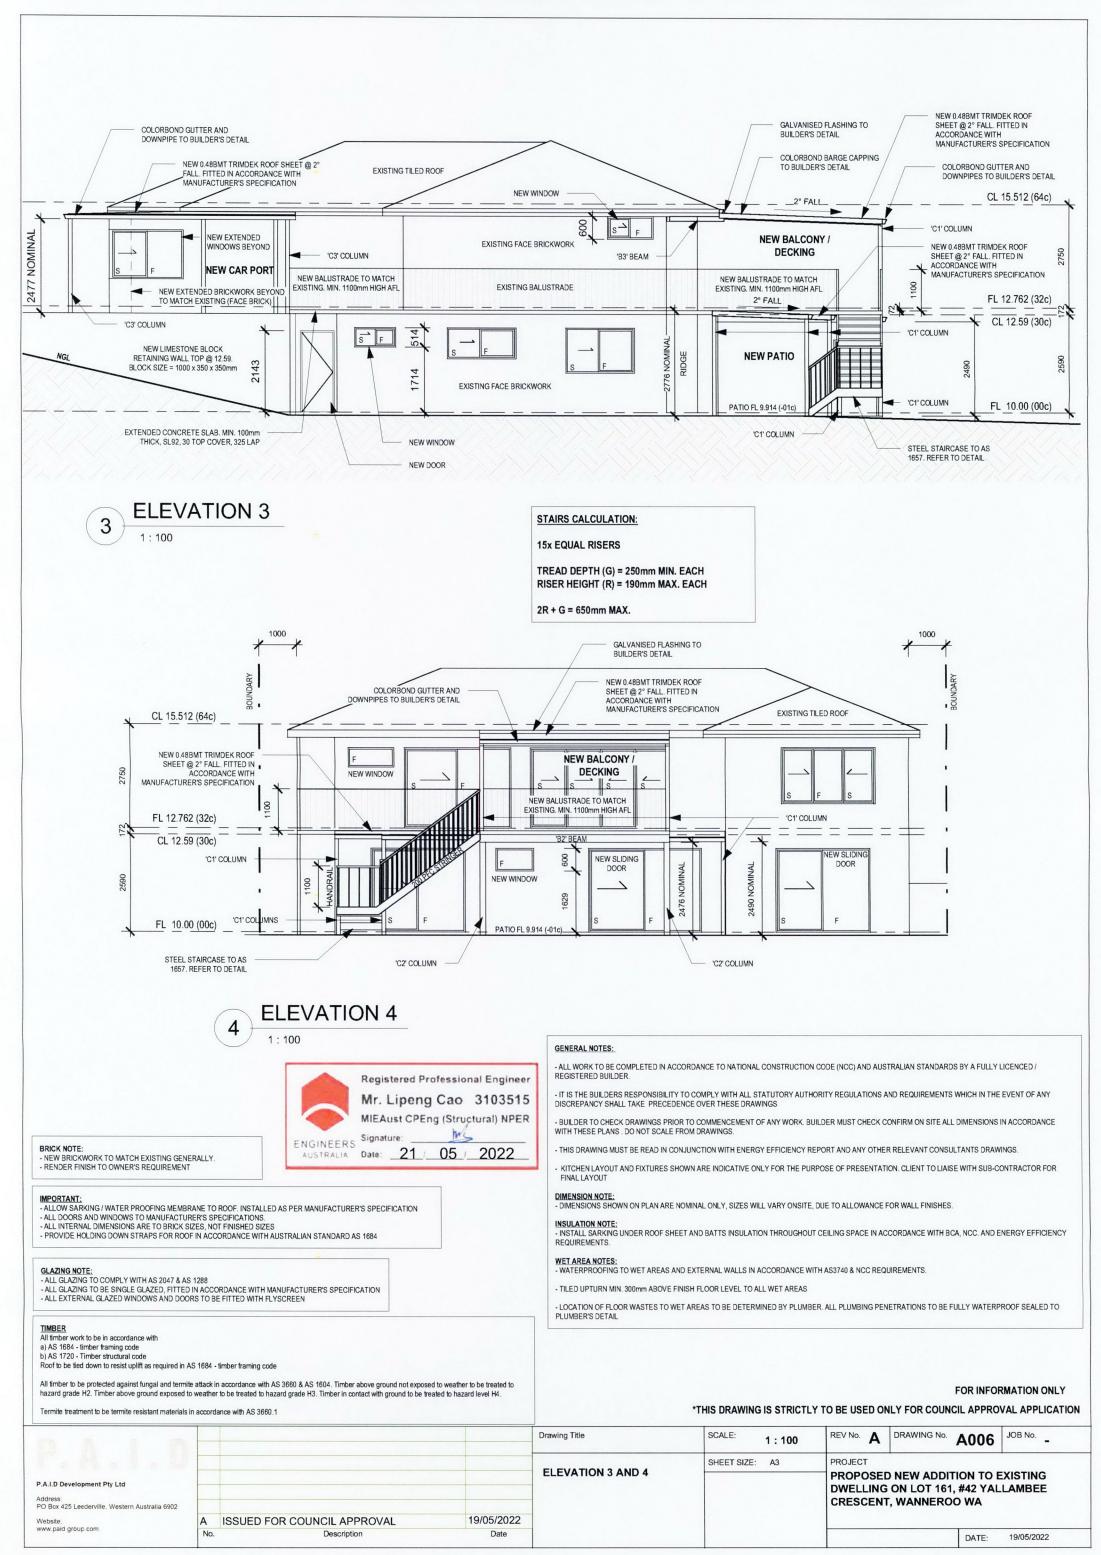

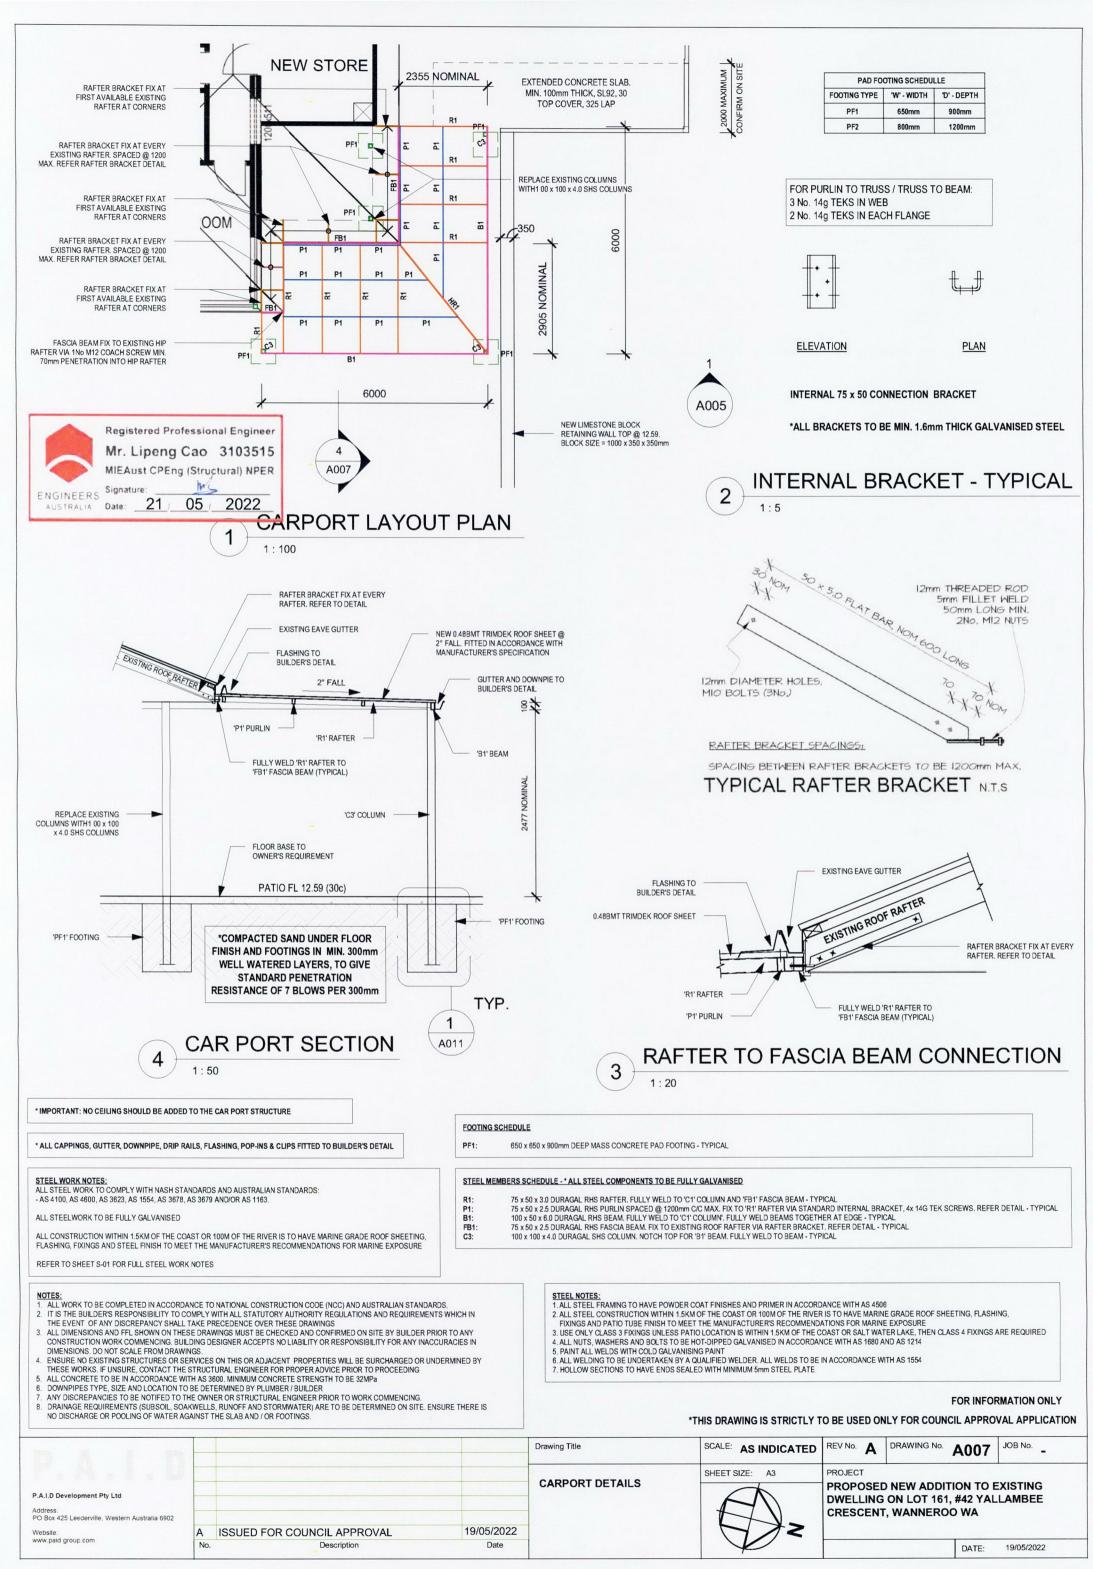

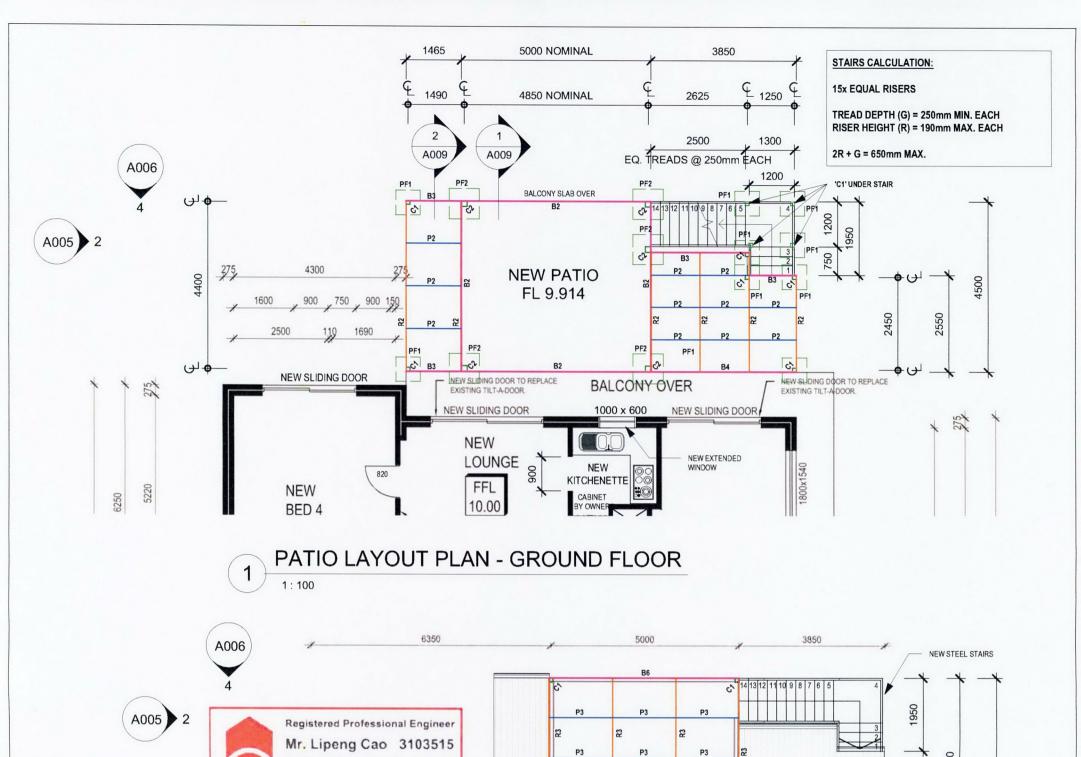

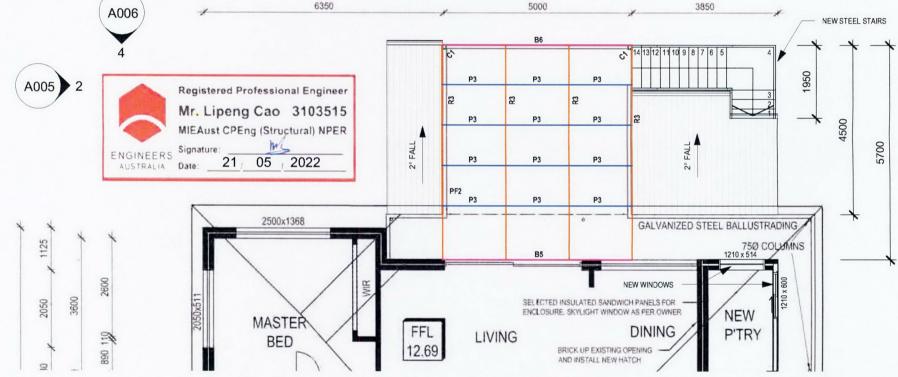

BALCONY DECK LAYOUT PLAN - FIRST FLOOR

* IMPORTANT: NO CEILING SHOULD BE ADDED TO THE PATIO AND BALCONY STRUCTURE

* ALL CAPPINGS, GUTTER, DOWNPIPE, DRIP RAILS, FLASHING, POP-INS & CLIPS FITTED TO BUILDER'S DETAIL

STEEL WORK NOTES: ALL STEEL WORK TO COMPLY WITH NASH STANDARDS AND AUSTRALIAN STANDARDS - AS 4100, AS 4600, AS 3623

ALL STEELWORK TO BE FULLY GALVANISED

ALL CONSTRUCTION WITHIN 1.5KM OF THE COAST OR 100M OF THE RIVER IS TO HAVE MARINE GRADE ROOF SHEETING, FLASHING, FIXINGS AND STEEL FINISH TO MEET THE MANUFACTURER'S RECOMMENDATIONS FOR MARINE EXPOSURE

FOOTING SCHEDULE

R2: R3: P2:

B2:

B3: B4: B5: B6:

 $650\times650\times900$ mm DEEP MASS CONCRETE PAD FOOTING - TYPICAL $800\times800\times1200$ mm DEEP MASS CONCRETE PAD FOOTING - TYPICAL

PAD FOOTING SCHEDULLE FOOTING TYPE 'D' - DEPTH W' - WIDTH 650mm 800mm 1200mm

STEEL MEMBERS SCHEDULE - * ALL STEEL COMPONENTS TO BE FULLY GALVANISED

100 x 50 x 5.0 DURAGAL RHS RAFTER. FULLY WELD TO 'C1' COLUMN AND 'B3' BEAM - TYPICAL 125 x 75 x 5.0 DURAGAL RHS RAFTER, FULLY WELD TO 'C1' COLUMN 'B5' & 'B6' BEAM - TYPICAL

75 x 50 x 2.5 DURAGAL RHS PURLIN SPACED @ 1200mm C/C MAX. FIX TO 'R2' RAFTER VIA STANDARD INTERNAL BRACKET, 4x 14G TEK SCREWS. REFER DETAIL - TYPICAL 75 x 50 x 2.5 DURAGAL RHS PURLIN SPACED @ 1200mm C/C MAX. FIX TO 'R3' RAFTER VIA STANDARD INTERNAL BRACKET, 4x 14G TEK SCREWS. REFER DETAIL - TYPICAL 200 PFC BEAM. FULLY WELD TO 'C2' COLUMN. FULLY WELD BEAMS TOGETHER AT CORNER - TYPICAL

100 x 50 x 3.0 DURAGAL RHS BEAM. FULLY WELD TO 'C1' COLUMN AND 'B2' BEAM. TYPICAL
100 x 50 x 5.0 DURAGAL RHS BEAM. FULLY WELD TO 'C1' COLUMN AND 'B2' BEAM. TYPICAL
125 x 75 x 3.0 DURAGAL RHS BEAM. FIX ONTO EXISTING BRICKWORK VIA M12 CHEMICAL ANCHOR BOLT @ 900 C/C MAX. MIN. 80mm EMBEDMENT INTO BRICKWORK

150 x 50 x 3.0 DURAGAL RHS BEAM, FULLY WELD TO 'B1' COLUMN - TYPICAL

100 x 100 x 3.0 SHS COLUMN, NOTCH TOP FOR BEAMS, FULLY WELD TO BEAMS - TYPICAL 150 x 150 x 9.0 SHS COLUMN, NOTCH TOP FOR BEAMS, FULLY WELD TO BEAMS - TYPICAL

REFER TO SHEET S-01 FOR FULL STEEL WORK NOTES

1. ALL WORK TO BE COMPLETED IN ACCORDANCE TO NATIONAL CONSTRUCTION CODE (NCC) AND AUSTRALIAN STANDARDS. 2. IT IS THE BUILDER'S RESPONSIBILITY TO COMPLY WITH ALL STATUTORY AUTHORITY REGULATIONS AND REQUIREMENTS WHICH IN

THE EVENT OF ANY DISCREPANCY SHALL TAKE PRECEDENCE OVER THESE DRAWINGS

1:100

ALL DIMENSIONS AND FFL SHOWN ON THESE DRAWINGS MUST BE CHECKED AND CONFIRMED ON SITE BY BUILDER PRIOR TO ANY CONSTRUCTION WORK COMMENCING. BUILDING DESIGNER ACCEPTS NO LIABILITY OR RESPONSIBILITY FOR ANY INACCURACIES IN DIMENSIONS, DO NOT SCALE FROM DRAWINGS.

ENSURE NO EXISTING STRUCTURES OR SERVICES ON THIS OR ADJACENT PROPERTIES WILL BE SURCHARGED OR UNDERMINED BY THESE WORKS. IF UNSURE, CONTACT THE STRUCTURAL ENGINEER FOR PROPER ADVICE PRIOR TO PROCEEDING ALL CONCRETE TO BE IN ACCORDANCE WITH AS 3600. MINIMUM CONCRETE STRENGTH TO BE 32MPa

DOWNPIPES TYPE, SIZE AND LOCATION TO BE DETERMINED BY PLUMBER / BUILDER

ANY DISCREPANCIES TO BE NOTIFED TO THE OWNER OR STRUCTURAL ENGINEER PRIOR TO WORK COMMENCING.

DRAINAGE REQUIREMENTS (SUBSOIL, SOAKWELLS, RUNOFF AND STORMWATER) ARE TO BE DETERMINED ON SITE. ENSURE THERE IS NO DISCHARGE OR POOLING OF WATER AGAINST THE SLAB AND / OR FOOTINGS.

STEEL NOTES:

1. ALL STEEL FRAMING TO HAVE POWDER COAT FINISHES AND PRIMER IN ACCORDANCE WITH AS 4506 2 ALL STEEL CONSTRUCTION WITHIN 1.5KM OF THE COAST OR 100M OF THE RIVER IS TO HAVE MARINE GRADE ROOF SHEETING. FLASHING

FIXINGS AND PATIO TUBE FINISH TO MEET THE MANUFACTURER'S RECOMMENDATIONS FOR MARINE EXPOSURE


3. USE ONLY CLASS 3 FIXINGS UNLESS PATIO LOCATION IS WITHIN 1.5KM OF THE COAST OR SALT WATER LAKE, THEN CLASS 4 FIXINGS ARE REQUIRED


4. ALL NUTS, WASHERS AND BOLTS TO BE HOT-DIPPED GALVANISED IN ACCORDANCE WITH AS 1680 AND AS 1214


5. PAINT ALL WELDS WITH COLD GALVANISING PAINT
6. ALL WELDING TO BE UNDERTAKEN BY A QUALIFIED WELDER. ALL WELDS TO BE IN ACCORDANCE WITH AS 1554
7. HOLLOW SECTIONS TO HAVE ENDS SEALED WITH MINIMUM 5mm STEEL PLATE

FOR INFORMATION ONLY


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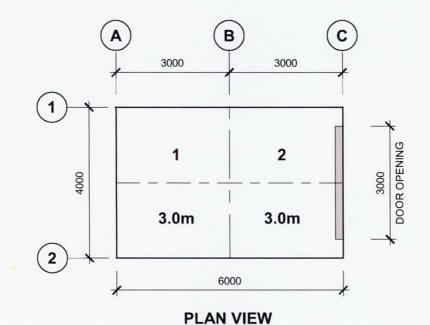


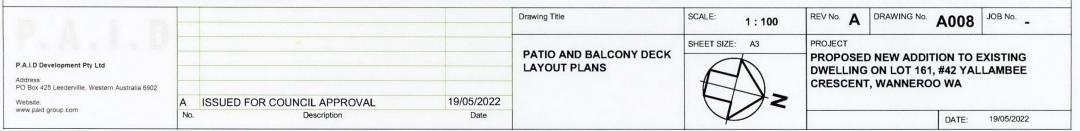


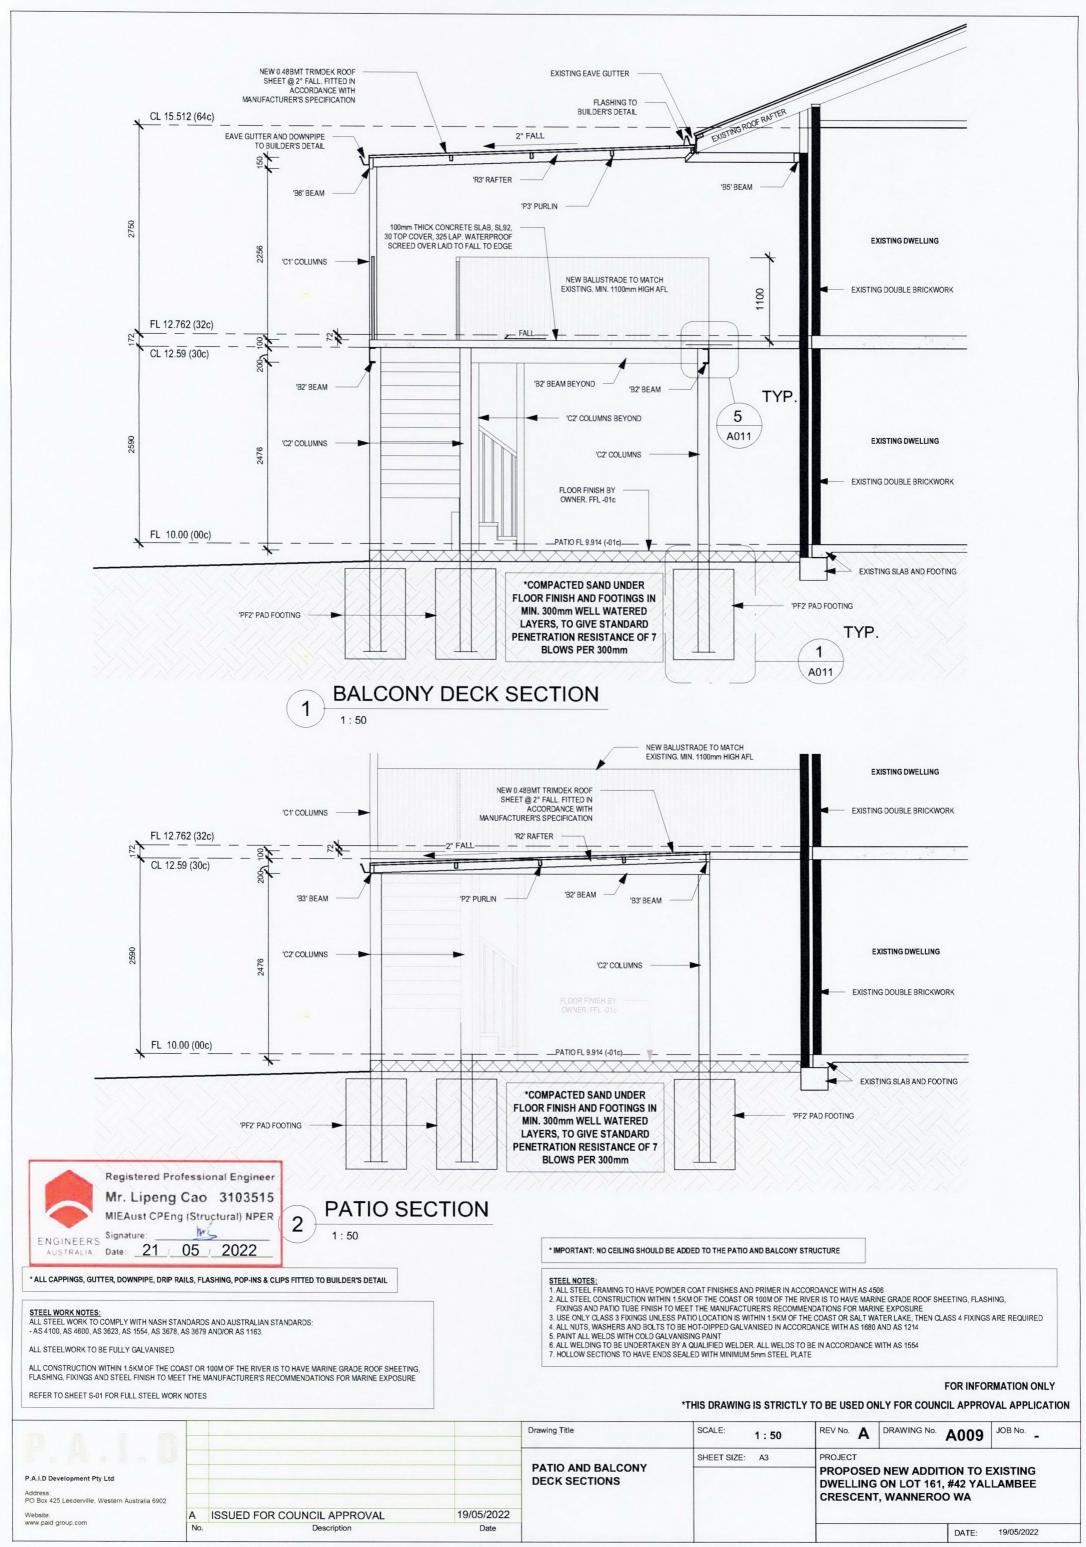


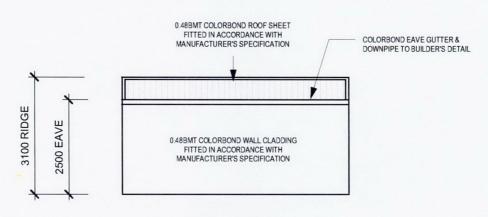WEST END



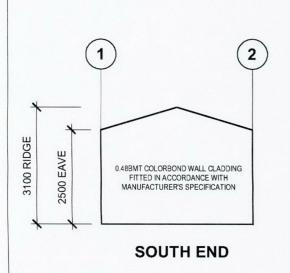

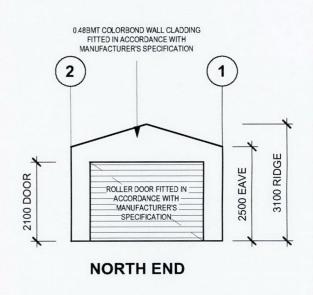

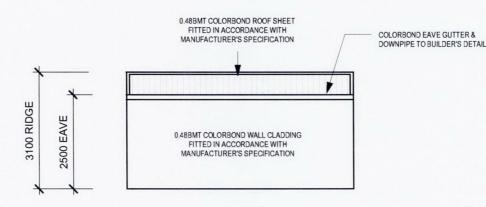

EAST END

*IMPORTANT: NO INTERNAL WALL OR CEILING SHOULD BE ADDED TO THE SHED STRUCTURE

* ALL CAPPINGS, GUTTER, DOWNPIPE, DRIP RAILS, FLASHING, POP-INS & CLIPS FITTED TO BUILDER'S DETAIL

STEEL WORK NOTES:
ALL STEEL WORK TO COMPLY WITH NASH STANDARDS AND AUSTRALIAN STANDARDS:
- AS 4100, AS 4600, AS 3623, AS 1554, AS 3678, AS 3679 AND/OR AS 1163.

ALL STEELWORK TO BE FULLY GALVANISED

ALL CONSTRUCTION WITHIN 1.5KM OF THE COAST OR 100M OF THE RIVER IS TO HAVE MARINE GRADE ROOF SHEETING, FLASHING, FIXINGS AND STEEL FINISH TO MEET THE MANUFACTURER'S RECOMMENDATIONS FOR MARINE EXPOSURE

REFER TO SHEET S-01 FOR FULL STEEL WORK NOTES

- 1. ALL WORK TO BE COMPLETED IN ACCORDANCE TO NATIONAL CONSTRUCTION CODE (NCC) AND AUSTRALIAN STANDARDS.
 2. IT IS THE BUILDER'S RESPONSIBILITY TO COMPLY WITH ALL STATUTORY AUTHORITY REGULATIONS AND REQUIREMENTS WHICH IN THE EVENT OF ANY DISCREPANCY SHALL TAKE PRECEDENCE OVER THESE DRAWINGS.
- ALL DIMENSIONS AND FFL SHOWN ON THESE DRAWINGS MUST BE CHECKED AND CONFIRMED ON SITE BY BUILDER PRIOR TO ANY CONSTRUCTION WORK COMMENCING, BUILDING DESIGNER ACCEPTS NO LIABILITY OR RESPONSIBILITY FOR ANY INACCURACIES IN DIMENSIONS. DO NOT SCALE FROM DRAWINGS.
- 4. ENSURE NO EXISTING STRUCTURES OR SERVICES ON THIS OR ADJACENT PROPERTIES WILL BE SURCHARGED OR UNDERMINED BY THESE WORKS. IF UNSURE, CONTACT THE STRUCTURAL ENGINEER FOR PROPER ADVICE PRIOR TO PROCEEDING

 5. ALL CONCRETE TO BE IN ACCORDANCE WITH AS 3600. MINIMUM CONCRETE STRENGTH TO BE 32MPa
- DOWNPIPES TYPE, SIZE AND LOCATION TO BE DETERMINED BY PLUMBER / BUILDER
 ANY DISCREPANCIES TO BE NOTIFED TO THE OWNER OR STRUCTURAL ENGINEER PRIOR TO WORK COMMENCING.
 DRAINAGE REQUIREMENTS (SUBSOIL, SOAKWELLS, RUNOFF AND STORMWATER) ARE TO BE DETERMINED ON SITE. ENSURE THERE IS
- NO DISCHARGE OR POOLING OF WATER AGAINST THE SLAB AND / OR FOOTINGS.



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