TRANSPORT IMPACT STATEMENT

Lot 1022 (No 150) St Andrews Drive, Yanchep

October 2023

Rev C



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1. Executive Summary

Site Context

- The subject site is currently an unoccupied landholding. Proponent is looking to construct a childcare centre with capacity for a maximum of 92 children at a time and 15 staff members.
- The proposed development fronts St Andrews Drive to the west and proposes one vehicular access/egress point. Proposed development plans are enclosed in Appendix 1 for clarity.

Technical Findings

- The navigability of the proposed parking area was checked with a B99 Passenger vehicle (5.2m). The analysis did not reveal any potential issues. Refer to Appendix 3 for the vehicle swept paths drawings.
- KCTT believe that a childcare centre does not require a specific bay for delivery vehicles, since
 deliveries can be conducted outside of peak hours of operation, when all drop-off parking bays will
 be empty.
- Waste collection can be conducted safely within the road reserve of St Andrews Drive. Alternatively,
 waste vehicles can perform on-site pickups, reversing from the street onto the site and leaving in
 forward gear.

Relationship with Policies

• The plans for the proposed development show a total of 23 car parking bays on site, inclusive of 1 ACROD, 10 tandem bays (2x5) for staff members and 12 standard car parking bays. Additionally, 2 car bays are provided in verge, raising the total number of parking bays to 25.

In accordance with the Local Planning Policy 2.3 a total of 29 parking bays are required, thereby resulting in a shortfall of 4 parking bays. On the other hand City of Wanneroo's District Planning Scheme No 2 stipulates a provision of a drive-in pickup/set down facility plus eight (8) bays for kindergarten's land use. If 8 car bays are set aside for staff members, while 25 car parking bays are provided in total, 17 bays left for a drop off function of the childcare centre.

KCTT believes that the childcare centre's pick up / drop off function can be effectively catered for and that would not negatively impact the surrounding area. This is elaborated in more detail in Section 2.7 of this report.

- The plans for the proposed development show a provision of 4 bicycle parking racks, which exceeds
 the requirement of 1 long stay bicycle bay for childcare centre in accordance with the Austroads'
 Guide to Engineering Practice Part 14: Bicycles.
- Building Code of Australia ACROD Provision The proposed plans demonstrate 1 ACROD bay, meeting the requirements outlined by the Building Code of Australia.

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Conclusion

• With the additional 402 daily vehicular trips, 74 vehicle trips in the AM peak and 64 vehicle trips in the PM peak the proposed development would have a moderate impact on the surrounding road network, per WAPC classification.

KCTT believe surrounding road network can accommodate additional traffic from the proposed development. In summary KCTT believe that the proposed development will not have a negative impact on the surrounding road network.

Germano Designs engaged KCTT to prepare a TIS for the proposed childcare centre at Lot 1022 (No 150) St Andrews Drive, Yanchep.

This report will primarily address the level impact of the proposed development and the requirements for integration of the proposed development with the surroundings, namely the existing and planned immediate road network.

2.1 Location

Lot Number 1022 Street Number 150

Road Name St Andrews Drive

Suburb Yanchep

Description of Site The subject site is currently an unoccupied landholding. Proponent is looking to

construct a childcare centre with capacity for a maximum of 92 children at a time and

15 staff members.

The proposed development fronts St Andrews Drive to the west and proposes 1 vehicular access/egress point. Proposed development plans are enclosed in Appendix 1

for clarity.

2.2 Technical Literature Used

Local Government Authority City of Wanneroo

Type of Development Childcare Centre - Individual Development

Are the R-Codes referenced? NO
Is the NSW RTA Guide to Traffic Generating Developments Version YES

2.2 October 2002 (referenced to determine trip generation /

attraction rates for various land uses) referenced?

Which WAPC Transport Impact Assessment Guideline should be Volume 4 - Individual Developments

referenced?

Are there applicable LGA schemes for this type of development? YES

If YES, Nominate:

Name and Number of Scheme District Planning Scheme No. 2 (Updated

to include AMD 172 GG 05/05/2023)

Are Austroads documents referenced?

Is the Perth Transport Plan for 3.5 million and Beyond referenced? NO

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2.3 Land Uses

Are there any existing Land Uses NO If <u>YES</u>, Nominate:

Proposed Land Uses

How many types of land uses are proposed? One (1)

Nominate land use type and yield Childcare Centre

92 children15 staff members

Are the proposed land uses complementary with the surrounding land-uses?

Subject lot is designated as "Residential – R40" in the City of Wanneroo's District Planning Scheme No 2.

Proposed land use – childcare is identified as 'D' use with the following meaning "A use class that is not permitted, unless the local government grants its approval after following the procedures laid down by subclause 6.2.2;"

2.4 Local Road Network Information

How many roads front the subject site?

One (1)

Name of Roads Fronting Subject Site / Road Classification and Description:

Road Name	St Andrews Drive
Number of Lanes	two way, one lane per direction, divided
Road Reservation Width	App.25m
Road Pavement Width	App.10m
Classification	Local Distributor
Speed Limit	50kph or State Limit
Bus Route	NO
If YES Nominate Bus Routes	-
On-street parking	NO

2.5 Traffic Volumes

Are traffic volumes available on Main Roads WA NO website?

Are traffic volumes provided by the Local Government?

By the time of writing this report KCTT didn't received the response from the City of Wanneroo's officer to request for available traffic data information if any. KC01437.000 Lot 1022 (No 150) St Andrews Drive, Yanchep

2.6 Vehicular Crash Information

Is Crash Data Available on Main Roads WA website?

Nominate analysed survey locations:

Location 1

Location 2

Period of crash data collection

Comment

NO

St Andrews Dr (SLK 1.31 – 1.59)

Intersection of St Andrews Drive & Birnam Court

01/01/2018 - 31/12/2022

No crashes were reported at the above locations

in the stated 5-year period.

2.7 Vehicular Parking

Local Government

Local Government Document Utilised

City of Wanneroo

City of Wanneroo's District Planning Scheme No 2

Local Planning Policy 2.3: Child Care Centres

Description of Parking Requirements in accordance with nominated documents:

City of Wanneroo's District Planning Scheme No 2 states the following:

16.1 The number of on-site car parking bays to be provided for specified development shall be in accordance with Schedule 11. Where development is not specified in Schedule 11 the local government shall determine the parking standard. The local government may also determine that a general car parking standard shall apply irrespective of the development proposed in cases where it considers this to be appropriate.

16.2 The design of off-street parking areas including parking for disabled shall be in accordance with Australian Standards AS2890.1 or AS2890.2 as amended from time to time. Car parking areas shall be constructed, marked, drained and thereafter maintained to the satisfaction of the local government.

SCHEDULE 11 - CAR PARKING STANDARDS

- childcare premises Per local planning policy but not less than 5
- Kindergarten Provision of a drive-in pickup/set down facility plus eight (8) bays."

Additionally, car parking requirements are prescribed within Local Planning Policy 2.3: Child Care Centres as follows:

^{&#}x27;Parking is to be provided on site at a rate of one parking bay for each staff member, in addition to the required number of bays as outlined in the table below"

children	Car bays required
25 or less	5
26-30	6
31-38	7
39-46	8
47-54	9
55 or more	9 bays plus 1 per 8 children accommodated in excess of 54

^{&#}x27;' CAR PARKING STANDARDS

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The same Policy states:

This policy has been prepared under Schedule 2, Part 2 of the Deemed Provisions of the Planning and Development (Local Planning Schemes) Regulations 2015 and is to be read in conjunction with the City of Wanneroo's (the City) District Planning Scheme No. 2 (DPS 2).

Calculation of Parking (in accordance with City of Wanneroo's District Planning Scheme No 2)

Land Use	Requirements	Yield	Total Parking
Childcare Centre	Provision of a drive-in pickup/set down facility plus eight (8) bays	n/a	8 +
	Total Car Par	king Requirement	8
			+ drop off bays
	of Parking (in accordance with Local Planning Policy 2.3: C Requirements	hild Care Centres) Yield	Total Parking
Calculation Land Use Childcare Centre			

Inclusive of. 23 car bays on site

2 bays on verge

25

Justification

The plans for the proposed development show a total of 23 car parking bays on site, inclusive of 1 ACROD, 10 tandem bays (2x5) for staff members and 12 standard car parking bays. Additionally, 2 car bays are provided in verge, raising the total number of parking bays to 25.

Total Volume of Parking Provided by Proponent

In accordance with the Local Planning Policy 2.3 a total of 29 parking bays are required, thereby resulting in a shortfall of 4 parking bays.

On the other hand City of Wanneroo's District Planning Scheme No 2 stipulates a provision of a drive-in pickup/set down facility plus eight (8) bays for kindergarten's land use. If 8 car bays are set aside for staff members, while 25 car parking bays are provided in total, 17 bays are left for a drop off function of the childcare centre.

Given the nature of the proposed land use and site context, the following points inform KCTT's opinion that the proposed parking can meet the development requirements:

- The capacity of the childcare centre is 92 children. It is highly unlikely that the childcare centre would always operate at the maximum legal capacity.
- The peak time for childcare centres is typically a 2-hour period. The average length of stay, as stated in NSW RTA Guide to Traffic Generating Developments, is 6.8 minutes. Even assuming conservative 10 minutes average length of stay, the actual arrivals/departure rate of parents with vehicles is likely to be spread throughout the 2-hour peak time. The AM peak is likely to be the peak development period as most parents drop off their children before going to work, whereas the PM peak tends to be more spread out with pick up times depending on when parents' become available.
- It is expected that staff would possibly cycle/walk to work.
- Adolescent staff will be dropped off.
- It is expected that some of patrons may be residents of the surrounding area since there are no other childcare centres within walking distance.

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The table below was derived through many years of practice and research in this field that our office completed. We have worked with a number of established childcare providers who have provided sign-in data for a full week period. The percentages outlined below have emerged as the current average arrival/departure pattern. As per our transport impact assessment, the estimated average dwell time is 10 minutes, which is significantly higher than dwell time suggested by NSW RTA Guide to Traffic Generating Developments.

While this pattern shows that up to 95% of children are in attendance for the day (as practically recorded), this distribution still does not allow for siblings attending the centre and assumes that all children in attendance are driven to the childcare in a separate personal vehicle (not walked or brought on bicycles), therefore the distribution below has a degree of conservativism.

In our previous experience, we have come across data indicating that siblings usually make up 15-25% of attendees. More than one child will be brought in a single vehicle in these cases, reducing the parking requirement.

The table below was developed on the following assumptions:

- The arrival percentage is derived from data provided to KCTT and described above.
- It was assumed there were no siblings in the centre.
- It was assumed that all children in attendance would be driven to the centre.

	Extracted Arrival Percentages	Expected Number of	Parking demand (assumed dwell	Parking Bays available for visitors on site (at any time)		
Sign-in Time	(of the maximum number of children)	Children Signing In	time 10 minutes per vehicle)	if 8 bays are designated for staff	If 10 bays are designated for staff	
07:00 - 07:30	13.97%	15	2.17 (3)	14	12	
07:30 - 08:30	40.55%	42	6.17 (7)	10	8	
08:30 - 09:30	30.68%	32	4.67 (5)	12	10	
09:30 - 10:30	7.67%	8	1.17 (2)	15	13	
After 10:30	1.37%	1	0.17 (1)	16	14	
Total:	94.25%	87 children (92 children – 100% capacity)				

As it could be seen in the table above, the parking demand is the strongest in the period from 07.30 till 08:30. When applied to the subject development with the assumed dwell time of 10 minutes per vehicle, the subject childcare centre would require a maximum of 7 car bays to cater for the expected parking demand of pick up / drop off function.

The calculation in a table above shows the number of parking bays available for visitors in 2 cases, when 8 or 10 car bays are dedicated to staff members. Having in mind that 8 or 10 drop off bays could be expected to be available in the period of the strongest parking demand, it could be concluded that each of the analysed arrangements provide a more than enough provision of parking bays to cater for the pickup / drop off function of the childcare centre.

Therefore, based on all above mentioned KCTT believe that pick up / drop off function of the childcare centre can be effectively catered for on premises and it is highly unlikely that the proposed development would have any negative impact. It is expected that the proposed 25 parking bays would adequately cater for the parking demand of the proposed development.

Have Vehicle Swept Paths been checked for Parking? YES

The navigability of the proposed parking area was checked with a B99 Passenger vehicle (5.2m) and a Medium Rigid Vehicle (8.8m) in 2 variations (with 9m and 12.5m curb to curb turning radius).. The analysis did not reveal any potential issues. Refer to Appendix 3 for the vehicle swept paths drawings.

2.8 Compliance with AS2890.1:2004 and AS2890.6

Number of Parking Bays on-site

Are Austroads documents referenced?

If YES, Nominate:

YES

23

Australian/New Zealand Standard, Parking facilities,
 Part 1: Off-street car parking - Originated as AS 2890.1—1986.

 Australian/New Zealand Standard, Parking facilities,
 Part 6: Off-street parking for people with disabilities - Originated as AS2890.6

Proposed development User Class

User Class 1A (Residential, domestic and employee parking)


User Class 3 (visitors' parking)

User Class 4

	AS2890.1:2004 Off-street car parking AS2890.6 Off-street parking for people with disabilities						
Parking Bay Type	Parking Bay Length		Parking Bay Width		Aisle Width		
	Required	Proposed	Required	Proposed	Required	Proposed	
All bays at 90° (User Class 1A)	5.4m	5.5m	2.4m	2.5m	5.8m	6.4m	
All bays at 90° (User Class 3)	5.4m	5.5m	2.6m	2.5m	5.8m	6.4m	
ACROD Parking	5.4m	5.5m	2.4m-ACROD 2.4m-shared space	2.5m–ACROD 2.5m–shared space	5.8m	6.4m	

Name the other requirements in the AS2890.1:2004 document.

In car parks open to the public, the maximum length of a blind aisle shall be equal to the width of six 90 degree spaces plus 1 m, unless provision is made for cars to turn around at the end and drive out forwards."

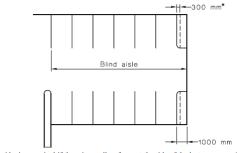

*Additional widening required if there is a wall or fence at the side of the last space, see Clause 2.4.1(b)(ii)

DIMENSIONS IN MILLIMETRES

FIGURE 2.3 BLIND AISLE EXTENSION

KCTT comment:

Single-sided aisles
Blind aisle
Reversing bay

Does the parking area meet the requirements set in AS2890.1:2004?

Not increased by 300 mm

Extended by a minimum of 1 m

Provided as shown on the layout plans enclosed in Appendix 1.

KCTT reviewed the proposed development layout and concluded that dimensions of all car parking bays and aisle width generally comply with the Australian Standard AS/NZS 2890.1/2004. The width of the parking bays for visitors' is

^{&#}x27;'At blind aisles, the aisle shall be extended a minimum of 1 m beyond the last parking space, as shown in Figure 2.3, and the last parking space widened by at least 300 mm if it is bounded by a wall or fence.

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below standard for User Class 3 but in line with Class 2 and having in mind the increased width of the aisle, KCTT believe this could adequately serve proposed land use.

Does the parking area meet the requirements set in AS2890.6?

YES

2.9 Compliance with AS 2890.5—1993 for on-street parking bays

Number of Parking Bays on-site 2 on-street bays on St Andrews Drive

Are regulatory documents referenced? YES

If YES, Nominate:

AS 2890.5—1993, Parking facilities, Part 5: On-street parking

	AS 2890.5—1993 requirement	Proposed
Parking Bay Width	For cars and light commercial vehicles, normal conditions - 2.3m	2.5m
Parking Bay	Length of intermediate space—6.0 m to 6.7 m, depending on parking turnover and traffic volume (see Note 3) Note 3 - Where parking turnover is high and vehicles backing into parking spaces	-
Length	Length of end space which is obstructed at one end by a kerb or barrier—6.3 m or length Z of adjacent space, whichever is the greater	6.5m

Name the other requirements in the AS2890.1:2004 document.

'Roadway width limitations for parallel parking

Width limitations which should be observed when determining the type of parking appropriate in a particular case, are as follows:

(a) Parallel parking Under low speed urban conditions, i.e. traffic speeds past the site generally not exceeding 60 km/h, the width from kerb to left-hand edge of the nearest moving traffic lane that should be provided is the parking space width from Table 2.1, plus 0.5 m clearance. This clearance should be increased by 1.0 m for each 10 km/h by which traffic speeds exceed 60 km/h, up to a maximum of 3.0 m."

Having in mind St Andrews Drive has a speed limit of 50kph and carriageway width of 10m for one-lane two-way traffic; there are no limitations for introducing parallel parking.

Does the parking area meet the requirements set in AS 2890.5—1993?

KCTT reviewed the proposed street parking bays and concluded that all car parking bays' dimensions comply with the Australian Standard AS 2890.5—1993.

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2.10 Bicycle Parking

Local Government City of Wanneroo

Reference Document Utilised District Planning Scheme No. 2

Austroads' Guide to Engineering Practice Part 14: Bicycles

Description of Parking Requirements in accordance with Scheme:

18.1 The local government may require the provision of bicycle parking and end of trip facilities such as showers, change rooms and lockers in commercial developments and other employment centres in accordance with Austroads' Guide to Engineering Practice Part 14: Bicycles."

Austroads' Guide to Engineering Practice Part 14: Bicycles has been replaced by Guide to Traffic Management Part 11: Parking, therefore KCTT have referenced the latter document:

Total Volume of Bicycle Parking Provided by Proponent

4 bicycle parking racks

Justification

The plans for the proposed development show a provision of 4 bicycle parking racks, which exceeds the requirement of 1 long stay bicycle bay for childcare centre in accordance with the Austroads' Guide to Engineering Practice Part 14: Bicycles.

2.11 ACROD Parking

Class of Building Class 1b (Child Care Centre);

Does this building class require specific YES

provision of ACROD Parking?

Reference Document Utilised Building Code of Australia

Description of Parking Requirements:

Class 1b — 1 space for every 100 carparking spaces or part thereof.

Parking Requirement in accordance with regulatory documents

• •	•		
Land Use	Requirements	Yield	Total Parking
Childcare	1 space for every 100 carparking spaces or part thereof	23	1
	Total Volume of ACROD Parl	king Required	1
	Total Volume of ACROD Parking Provided	by Proponent	1

Justification

The proposed plans demonstrate 1 ACROD bay, meeting the requirements outlined by the Building Code of Australia.

[&]quot; Bicycle Parking and End of Trip Facilities

[&]quot; Child day care centre: Bicycles (long-stay) -1 space"

2.12 Delivery and Service Vehicles

Guideline Document used as reference

NSW RTA Guide to Traffic Generating Developments

Requirements

Other uses - 1 space per 2,000m2

Parking Requirement in accordance with regulatory documents

Land Use	Minimum Requirements	Yield	Total Parking				
Childcare	1 space per 2,000m2	<2,000m ²	1				
Total Volume of Service and Delivery Parking Required							
Total Volume of Service and Delivery Parking Provided by Proponent							

Justification

The above requirements are only stated as a guide. KCTT believe that a childcare centre does not require a specific bay, since all deliveries can be conducted outside of peak hours of operation when all drop-off parking bays will be empty.

Waste collection can be conducted safely within the road reserve of St Andrews Drive. Alternatively, waste vehicles can perform on-site pickups, reversing from the street onto the site and leaving in forward gear. This operation is exemplified using a Medium Rigid Vehicle (8.8m) in 2 variations (with 9m and 12.5m curb to curb turning radius), as illustrated in plans S40 and S41 found in Appendix 3 for enhanced clarity.

2.13 Calculation of Development Generated / Attracted Trips

What are the likely hours of operation? What are the likely peak hours of operation?

Child Care Centre – 07:00-19:00 07:00 - 08:00 and 16:00 - 17:00

Do the development generated peaks coincide with existing road network peaks?

YES

If YES, Which:

Both

Guideline Document Used

Rates from above document:

NSW RTA Guide to Traffic Generating Developments

Child Day Care:

- AM Peak 0.8 VPH per child
- PM Peak 0.7 VPH per child

It should be noted that these rates are given for a 2-hour peak period. For the purposes of this report KCTT assumes that the two-hour traffic volume will be attracted to the development in one hour period that will represent the peak for the subject site.

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Given that the WAPC Transport Assessment Guidelines and NSW RTA Guide to Traffic Generating Developments do not offer daily vehicular trip generation rate for the proposed land use KCTT have assumed the following to apply:

Childcare centre

Vehicular daily trips can be assumed to be 4 VPD per child and 2 VPD per employee. Each parent will make 2 vehicular trips when dropping off the child to the day care centre and 2 vehicular trips when picking the child up. Employees will make 1 vehicular trip arriving to work, and another vehicular trip when leaving work.

In our experience, childcare centres tend to operate with up to 95% utilisation rate of the licenced capacity over the year due to a number of days those children attend (this ranges from 2 to 5 days a week) and seasonal adjustments (end of year and when people return to work from maternity leave). Therefore, the expected average daily operative maximum of this childcare facility can be estimated as 99 children. Market information indicates that between 10-20 parents have more than one child at the centre so those families only account for one vehicular trip. A further % of parents will have older siblings attending one of the nearby schools.

However, in the calculations below, a conservative approach has been applied showing the theoretical maximum number of children, under assumption that all children are driven to school and there are no siblings in the centre.

Does the site have existing trip generation / attraction?

NO

Land Use Type	Rate above	Yield	Daily Traffic Generation	Peak Hour Traffic Generation		
			acheration	AM	PM	
Child Care	Daily - 4 VPD per child and 2 VPD per staff member AM Peak - 0.8 VPH per child PM Peak - 0.7 VPH per child	92 children 15 staff	368 30	74	64	
	Total Traffic impact of the proposed de	398	74	64		

What is the total impact of the new proposed development?

With the additional 398 daily vehicular trips, 74 vehicle trips in the AM peak and 64 vehicle trips in the PM peak the proposed development would have a moderate impact on the surrounding road network, per WAPC classification.

KCTT believe surrounding road network can successfully accommodate additional traffic from the proposed development.

2.14 Traffic Flow Distribution

How many routes are available for access / egress to the site? One

Route 1 / Movement 1

Provide details for Route No 1

From/to the south via St Andrews Drive

Percentage of Vehicular Movements via Route No 1

100%

Note – expected traffic flow distribution is based on a currently existing road network as shown on proposed development plans enclosed in Appendix 1. It could be expected that the surrounding area will be further

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developed and St Andrews Drive extended, given that currently the cul-de-sac of this street is adjacent to the subject development site, it's clear that all the traffic generated by the proposed development will be distributed to the south. If the road is extended in future traffic flow is likely to be redistributed.

For more detailed plans of the estimated vehicular traffic volumes and distribution, please refer to the plans provided in Appendix 2.

2.15 Vehicle Crossover Requirements

Are vehicle crossovers required onto existing road networks? YES

How many existing crossovers?

How many proposed crossovers?

One

If there are greater numbers of new crossovers, than existing, provide justification:

An access to the road network via crossover must be provided for each development.

How close are proposed crossovers to existing intersections? Approximately 20m

Does this meet existing standards? YES

Justification

According to AS/NZS 2890.1:2004 Parking facilities Part 1: Off-street car parking the user class of the access point is: User Class 1 - Employee and commuter parking Proposed development plans indicate a total of 23 parking bays on site and 1 crossover.

This crossover serves less than 25 parking bays from a local road, making it a "Category 1 driveway"

TABLE 3.1 SELECTION OF ACCESS FACILITY CATEGORY

Class of parking		Access facility category											
facility	Frontage road type		Number of parking spaces (Note 1)										
(see Table 1.1)		<25	25 to 100	101 to 300	301 to 600	>600							
1,1A	Arterial	1	2	3	4	5							
	Local	1	1	2	3	4							
2	Arterial	2	2	3	4	5							
	Local	1	2	3	4	4							
3,3A	Arterial	2	3	4	4	5							
	Local	1	2	3	4	4							

NOTES:

- 1 When a car park has multiple access points, each access should be designed for the number of parking spaces effectively served by that access.
- 2 This Table does not imply that certain types of development are necessarily suitable for location on any particular frontage road type. In particular, access to arterial roads should be limited as far as practicable, and in some circumstances it may be preferable to allow left-turn-only movements into and out of the access driveway.


Therefore, the following requirements from AS/NZS 2890.1:2004 Parking facilities Part 1: Off-street car parking apply:

"(a) Driveway Categories 1 and 2: At unsignalized intersections of sub-arterial, collector or local streets with each other or with an arterial road, access driveways in Categories 1 and 2 (see Table 3.1) shall not be located in the sections of kerb shown by heavy lines in Figure 3.1.

This requirement shall not apply to accesses to domestic driveways in the kerb section opposite the entering road at any intersection including signalized intersections.

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Furthermore, it shall not apply to any access driveway serving a property which would otherwise be denied access due to the physical impossibility of meeting the requirement.

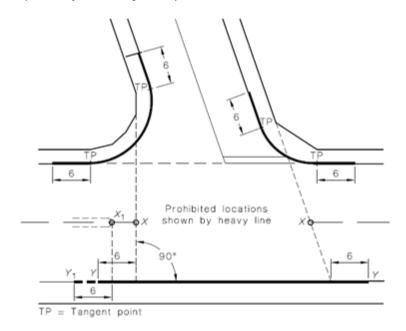

NOTES:

- 1 Accesses to domestic driveways are excluded from the prohibition in respect of the kerb section marked Y-Y (see Clause 3.2.3(a)).
- 2 The points marked X₁ and X are respectively at the median end on a divided road and at the intersection of the main road centre-line and the extensions of the side road property lines shown as dotted lines, on an undivided road. On a divided road, dimension Y-Y extends to Point Y₁.

DIMENSIONS IN METRES

FIGURE 3.1 PROHIBITED LOCATIONS OF ACCESS DRIVEWAYS

As shown on the layout for the proposed development in Appendix 1, the proposed crossover is not located in any of the areas shown by heavy lines and therefore complies with the AS/NZS 2890.1:2004 requirements

2.16 Pedestrian Safety

Are sight distances adequate for pedestrian safety? YES Justification

There is more than 4.7m distance between the edge of the fence and the edge of the pedestrian path. Given the position of the rear-view mirror and wing mirrors on the vehicle - the driver would be able to see the pedestrian well before any part of the vehicle encroaches the footpath. Also, any pedestrian on the path would have more than enough sight line to see the egressing vehicle. Pedestrians walking along the verge would be an absolute minority and limited to delivery people (post is distributed in motorised vehicles in general).

Clearance between the path and the fence (>4.7m) is more than sufficient for the pedestrian to clearly see and hear the vehicle leaving the driveway and to adjust their behaviour.

In addition, MRWA data base do not have any records of any incident along St Andres Drive occurring within last 5 years.

KC01437.000 Lot 1022 (No 150) St Andrews Drive, Yanchep

2.17 Public Transport Accessibility

How many bus routes are within 400 metres of the subject site?

None
How many rail routes are within 800 metres of the subject site?

None

Walk Score Rating for Accessibility to Public Transport

n/a -

Is the development in a Greenfields area?

2.18 Pedestrian Infrastructure

Describe existing local pedestrian infrastructure within a 400m radius of the site:

Does the site have existing pedestrian facilities YES

Does the site propose to improve pedestrian facilities?

If YES, describe the measures proposed.

The proposed walkway and covered entry veranda allow the pedestrian connection of the existing pedestrian path on St Andrews Drive and pedestrian entrances of the proposed facility.

YES

What is the Walk Score Rating?

O Car-Dependent. Almost all errands require a car.

2.19 Cyclist Infrastructure

Are there any PBN Routes within an 800m radius of the subject site?

Although there are no bike routes classified by the Department of Transport, the area surrounding the subject site could be consider as very cycling friendly and provides good connectivity through the area.

Are there any PBN Routes within a 400m radius of the subject site?

Does the site have existing cyclist facilities?

Does the site propose to improve cyclist facilities?

If YES, describe the measures proposed.

The plans for the proposed development show a provision of 4 bicycle parking racks

KC01437.000 Lot 1022 (No 150) St Andrews Drive, Yanchep

2.20 Site-Specific Issues and Proposed Remedial Measures

How many site-specific issues need to be discussed? One

Site-Specific Issue No 1	Parking provision
Remedial Measure / Response	KCTT believes that the childcare centre's pick up / drop off function can be effectively catered for and that would negatively impact the surrounding area. This is elaborated in more detail in Section 2.7 of this report.

Appendix 1

The Layout of the Proposed Development

MAC HOMES

Address:Lot 1022 (#150) St Andrews Drive, YANCHEP

Childcare Centre

Job Number: 21109





Unit: 3/1 Mulgul Road, Malaga W.A 6090

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Drawing NoDescriptionPD01Cover SheetPD023DPD03Existing Site SurveyPD04Site PlanPD05Context PlanPD06Floor Plan







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ROSS McLOUGHLIN
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JOONDALUP: UNIT 1, 9 MERCER LANE
LANCELIN: 4 SALVAIRE CRESCENT
MOBILE 0419 255 999
EMAIL rossmac@iinet.net.au

 LOT 1020 (No.150) ST ANDREWS DRIVE - YANCHEP

 SITE PLAN - STRATA LOT 9

 SCALE:
 1:200 @ A1 SIZE
 LOCAL AUTHORITY: CITY OF WANNEROO
 SURVEYOR: RAM

 DATE:
 24.7.2019
 PLAN: LOT 9 ON STRATA PLAN 70720
 DRAWN: RAM

 DATUM:
 AHD
 AREA: 4138m 2
 SDR FILE: YP5

CHECK CERTIFICATE OF TITLE FOR EASEMENTS, RESTRICTIVE COVENANTS, ETC.

THIS SURVEY DOES NOT GUARANTEE THE CORRECT POSITION OF BOUNDARY PEGS OR FENCES.


ALL FEATURES AND BUILDING POSTIONS ARE APPROXIMATE ONLY, AS THEY HAVE BEEN POSITIONED FROM MEASUREMENTS TAKEN FROM EXISTING PEGS, FENCES AND WALLS. INFORMATION SHOWN ON THIS PLAN IS CURRENT AT THE DATE SHOWN.


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CADASTRAL BOUNDARY DIMENSIONS SHOWN HAVE BEEN OBTAINED FROM SURVEY PLANS AND ARE SUBJECT TO FIELD SURVEY.

A BOUNDARY RE-ESTABLISHMENT SURVEY IS RECOMMENDED PRIOR TO UNDERTAKING ANY SITE WORKS OR CONSTRUCTION.





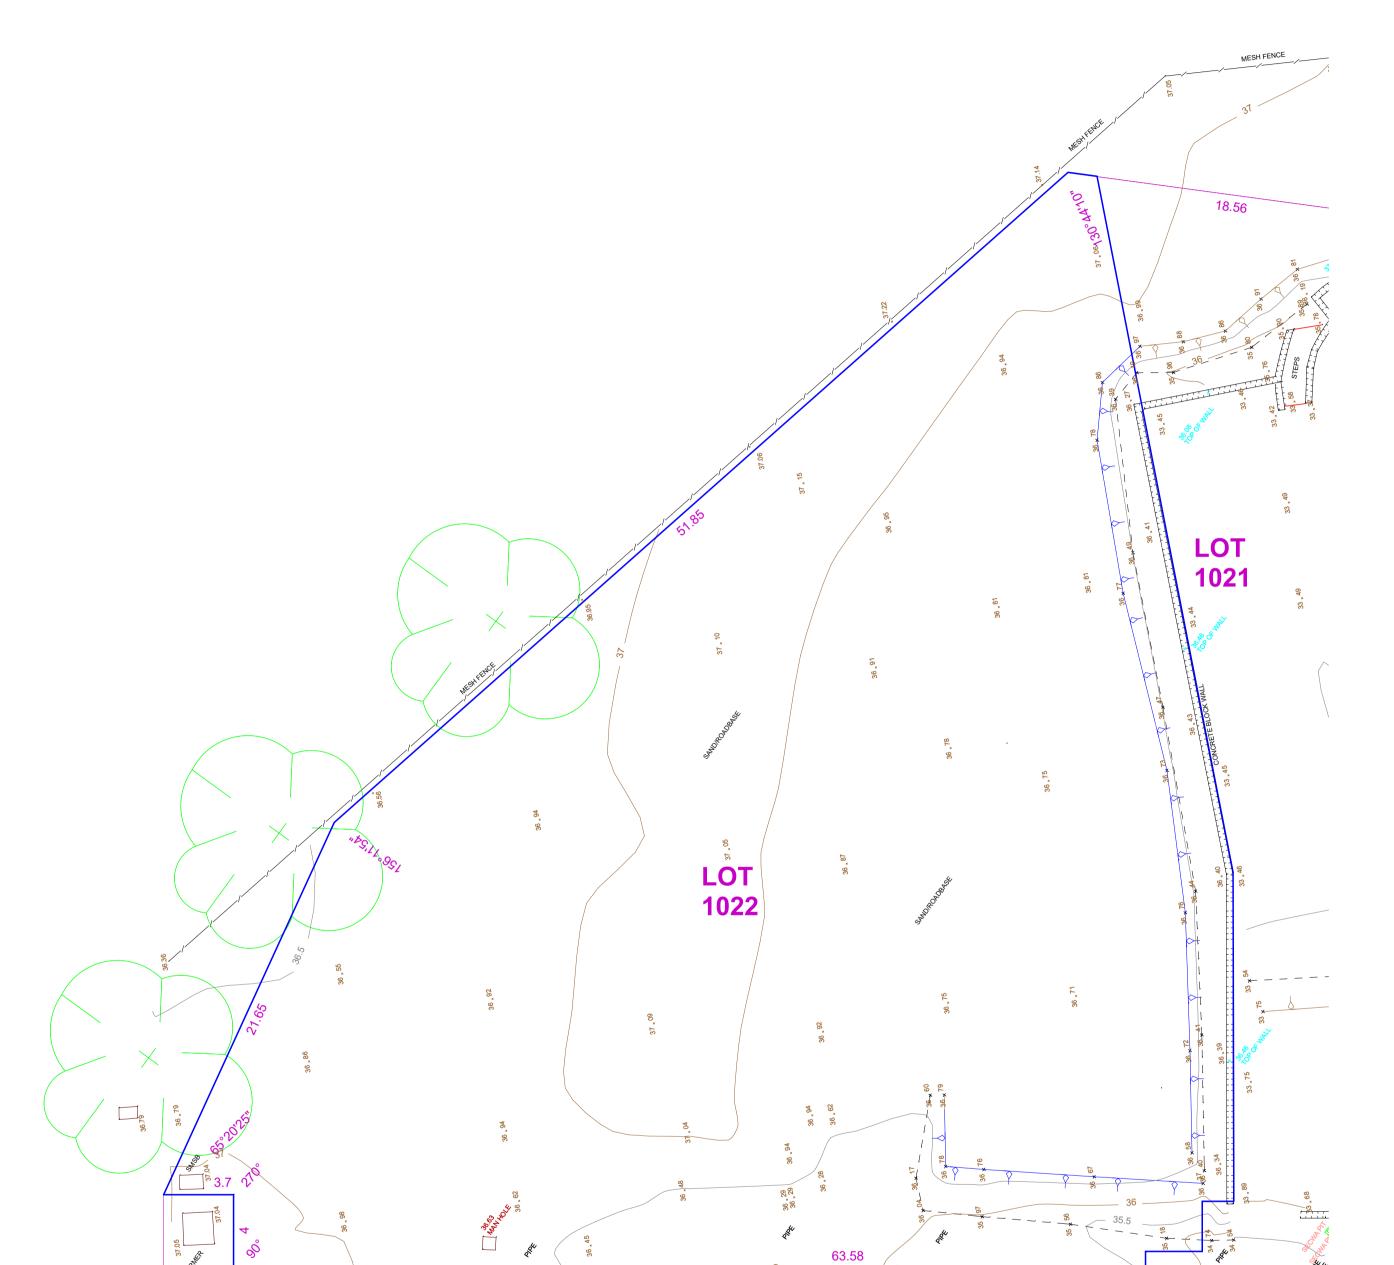

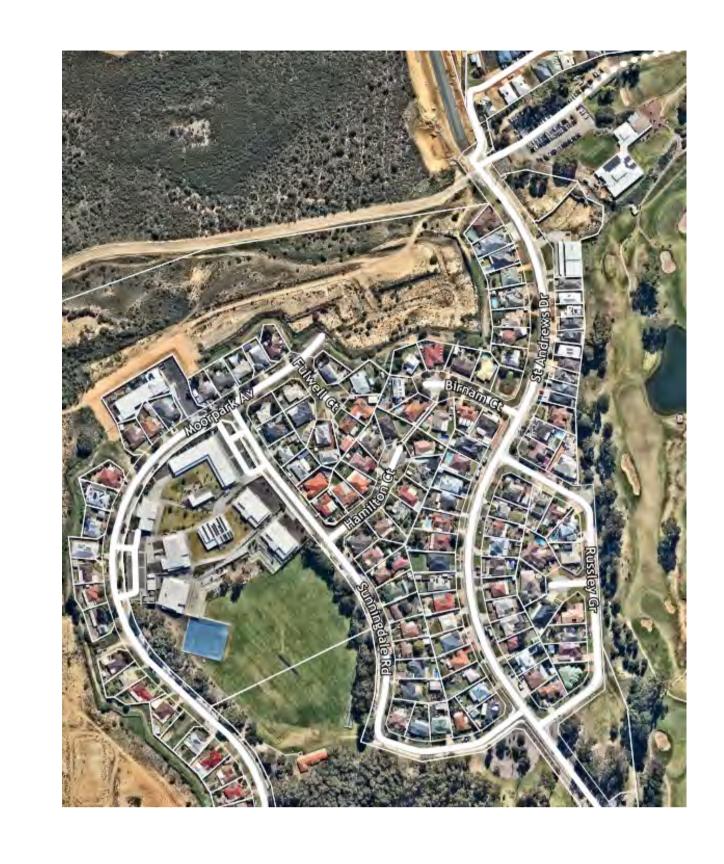

Scale 1:200



Client	Drawing Title:		Issue:				Revision	Description	Date	Ī
MAC HOMES	Existing Site Survey			ment Approval			007	Planning Drawings	31.07.23	l
	Latisting Site Survey			ment Approvai			006	Sketch	29.07.22	l
Project Name	Scale: as noted	Sheet Size: A1	Rev:	Description:		Drawn:	005	Sketch	24.02.22	l
Childcare Centre		Danish a Na	007	Planning Drawing	ıs	CD	004	Sketch	22.02.22	l
Project Address	Project No:	Drawing No.:			,		003	Sketch	11.02.22	Ē
Lot 1022 (#150) St Andrews Drive, YANCHEP	21109	PD03 of 07		Number:	Date:		002	Sketch	20.01.22	H
			007		31 07 2023					1 //

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ROSS McLOUGHLIN CONSULTING SURVEYOR JOONDALUP: UNIT 1, 9 MERCER LANE LANCELIN: 4 SALVAIRE CRESCENT MOBILE 0419 255 999 EMAIL rossmac@iinet.net.au


LOT 1020 (No.150) ST ANDREWS DRIVE - YANCHEP SITE PLAN - STRATA LOT 9 SCALE: 1:200 @ A1 SIZE LOCAL AUTHORITY: CITY OF WANNEROO SURVEYOR: RAM DATE: 24.7.2019 DRAWN: RAM PLAN: LOT 9 ON STRATA PLAN 70720 SDR FILE: YP5 DATUM: AREA: 4138m ²


CHECK CERTIFICATE OF TITLE FOR EASEMENTS, RESTRICTIVE COVENANTS, ETC. THIS SURVEY DOES NOT GUARANTEE THE CORRECT POSITION OF BOUNDARY PEGS OR FENCES. ALL FEATURES AND BUILDING POSTIONS ARE APPROXIMATE ONLY, AS THEY HAVE BEEN POSITIONED FROM MEASUREMENTS TAKEN FROM EXISTING PEGS, FENCES AND WALLS. INFORMATION SHOWN ON THIS PLAN IS CURRENT AT THE DATE SHOWN. ROSS McLOUGHLIN SURVEYS ACCEPTS NO RESPONSIBILITY FOR ANY CHANGES THAT HAVE OCCURED AFTER THIS DATE TO SITE LEVELS, FEATURES OR BUILDINGS. CADASTRAL BOUNDARY DIMENSIONS SHOWN HAVE BEEN OBTAINED FROM SURVEY PLANS AND ARE SUBJECT TO FIELD SURVEY.

A BOUNDARY RE-ESTABLISHMENT SURVEY IS RECOMMENDED PRIOR TO UNDERTAKING ANY SITE WORKS OR CONSTRUCTION.





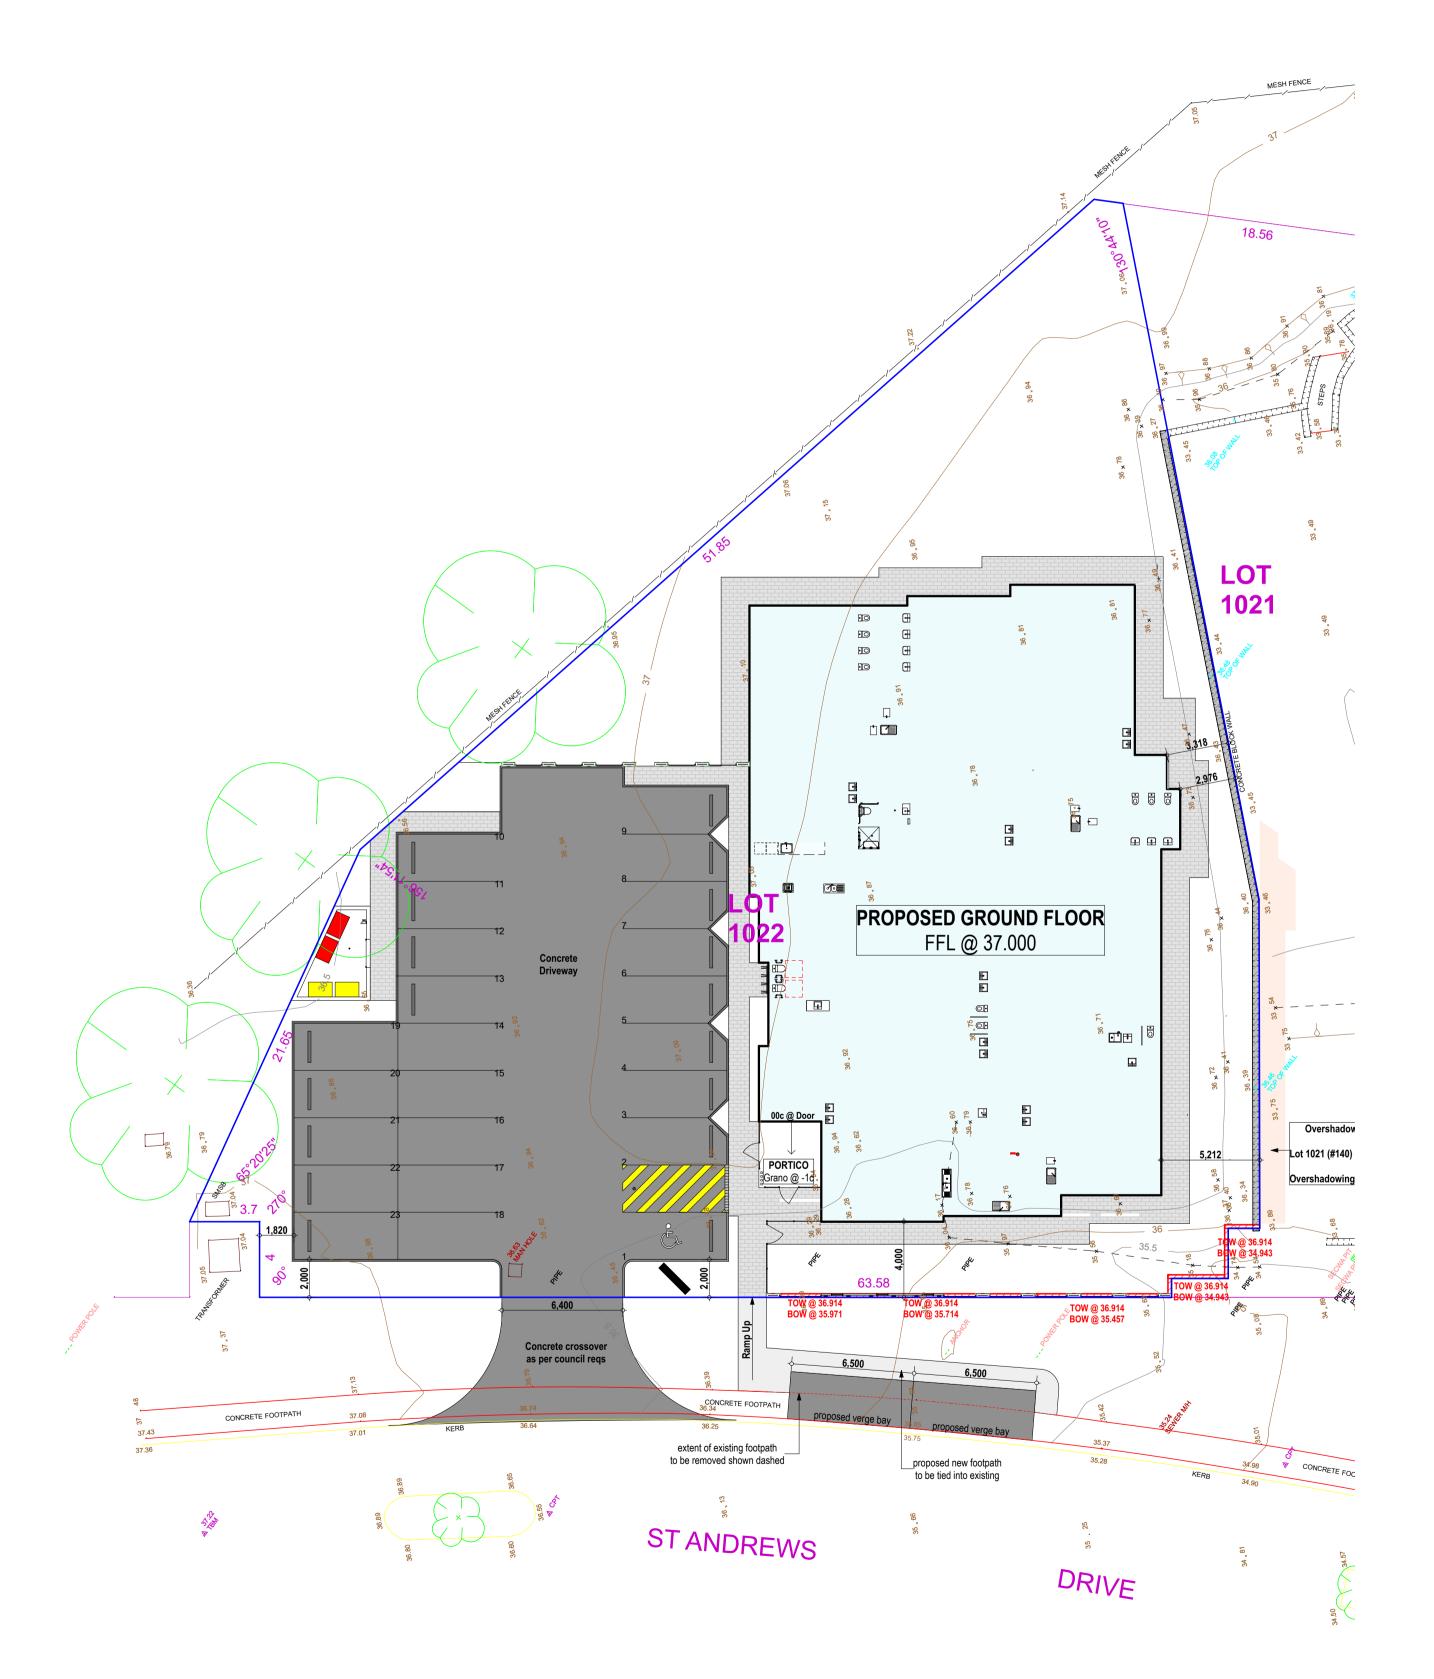

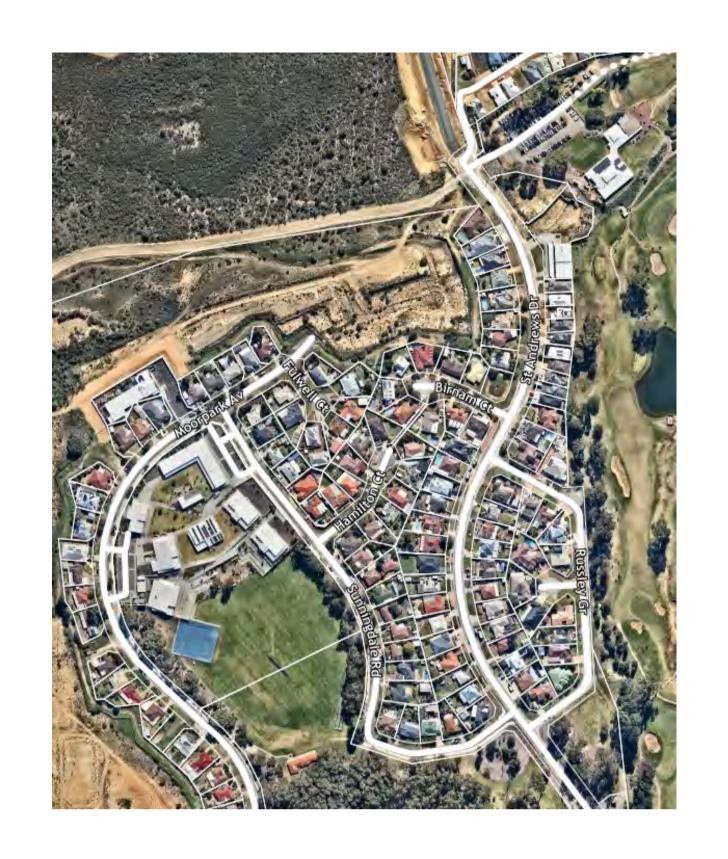



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Client	Drawing Title:		Issue:	Issue:			Revision	Description	Date		
MAC HOMES	Site Plan			Development Approval			007	Planning Drawings	31.07.23		GERMAN
	Olto Fidir		Dovolop	Dovelopment Approval				Sketch	29.07.22		
Project Name	Scale: as noted	Sheet Size: A 1	Rev:	Description:		Drawn:	005	Sketch	24.02.22		
Childcare Centre		Danie Na	007	Planning Drawin	as	CD	004	Sketch	22.02.22	1	
Project Address	Project No:	Drawing No.:			1	1	003	Sketch	11.02.22	Linite 2/4 Medaed Day	-d Malana W A COOO
Lot 1022 (#150) St Andrews Drive, YANCHEP	21109	PD04 of 07	Revision	Number:	Date:		002	Sketch	20.01.22	Unit: 3/1 Mulgui Roa	ad, Malaga W.A 6090
			007		31.07.2023		001	Concept Design	19.01.22	(08) 9248 8392	www.germanodesigns.com.au





144 St Andrews Dr. Yanchep




Residential - St Andrews Drive



Yanchep Rise Primary School

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	Contoxt i ian		Develop				006	Sketch	29.07.22	GERMANO		
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B. d. d. A. I. L	Project No:	Drawing No.:	007	Planning Draw	ings	CD		Sketch	11.02.22		@OODVDIOUT	
Project Address	104400	DD05 of 07	Revision	n Number:	Date:					Unit: 3/1 Mulgul Road, Malaga W.A 6090	© COPYRIGHT This plan shall remain the sole property of	
Lot 1022 (#150) St Andrews Drive, YANCHEP	21109	PD05 of 07					002	Sketch	20.01.22		GERMANO DESIGNS and must not be given,	
			007		31.07.2023		001	Concept Design	19.01.22	(08) 9248 8392 www.germanodesigns.com.au	resold or otherwise disposed or copied witho permission in writing of the company.	

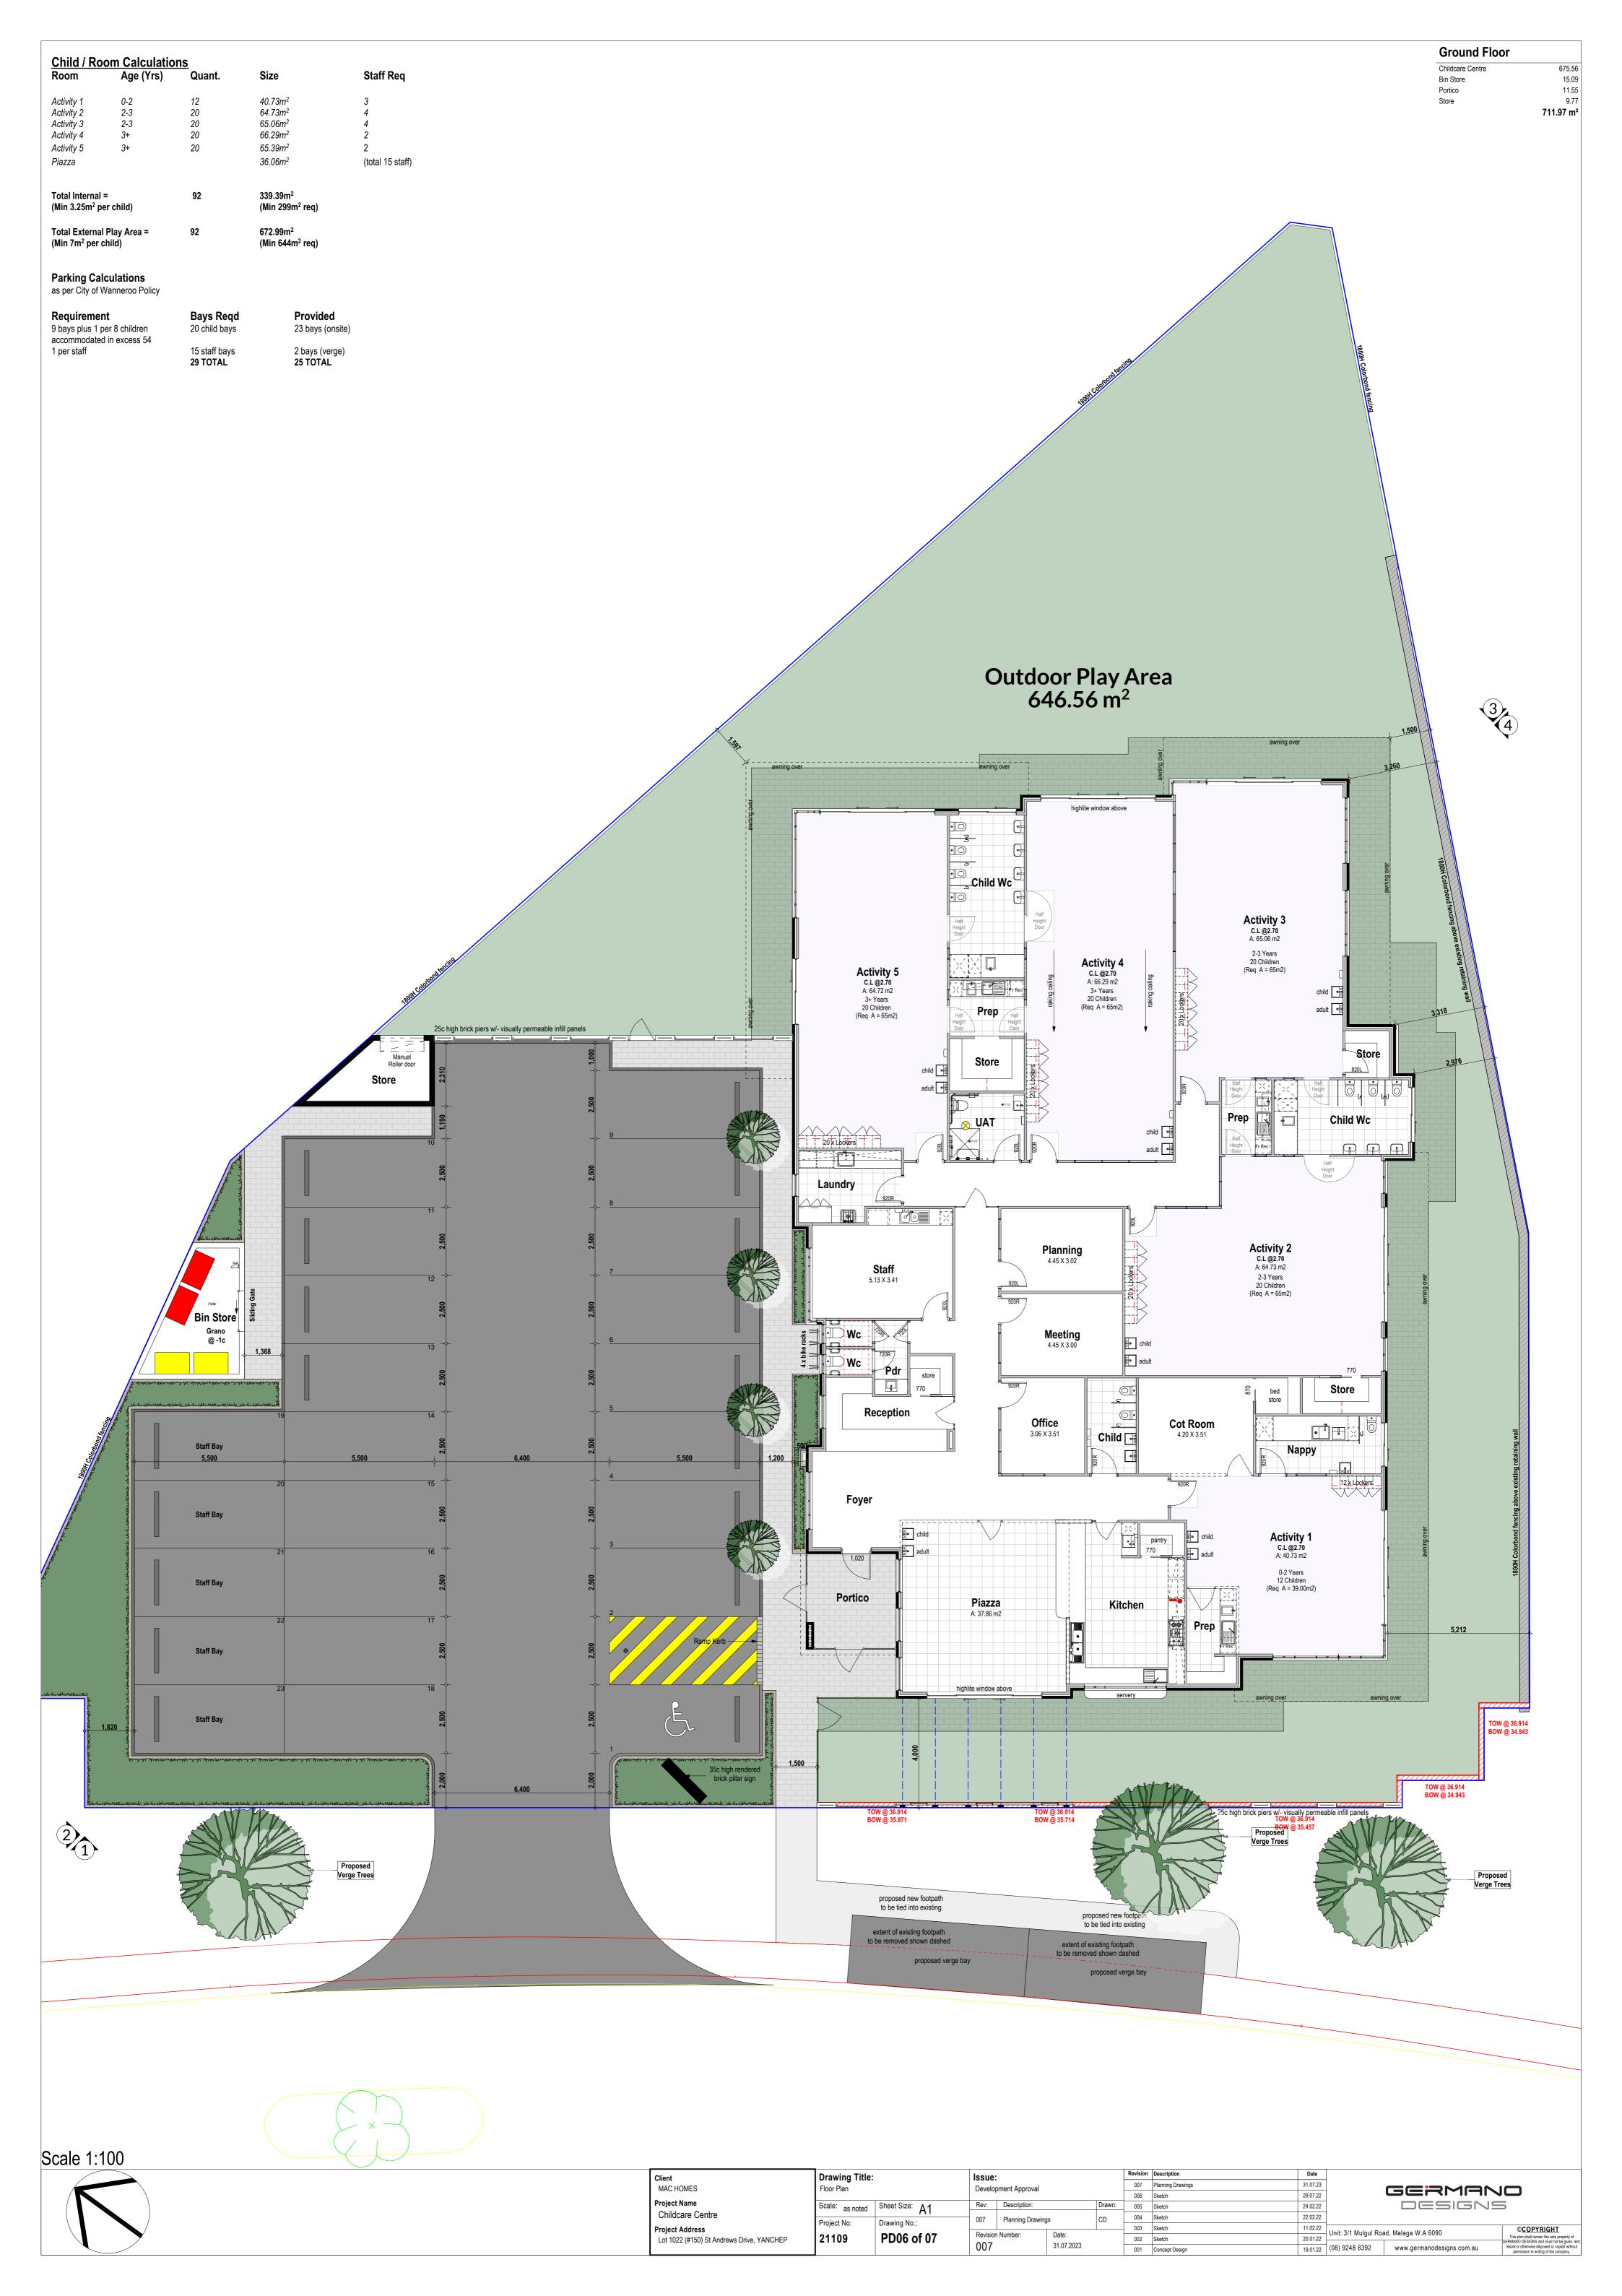

Material & Colour Schedule



Acrylic Render Dulux "Mt Aspiring"



Acrylic Render Dulux "Champignon"



Face Brick Midland Brick Recycled




Vertical Cladding "Axon Cladding"




Colorbond Roof "Monument" "Marble Black Satin"


Window Frames

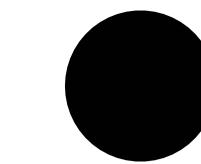

Awning Dulux "Mt Aspiring

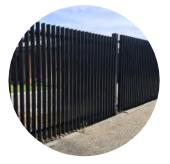


P/Coated Fence

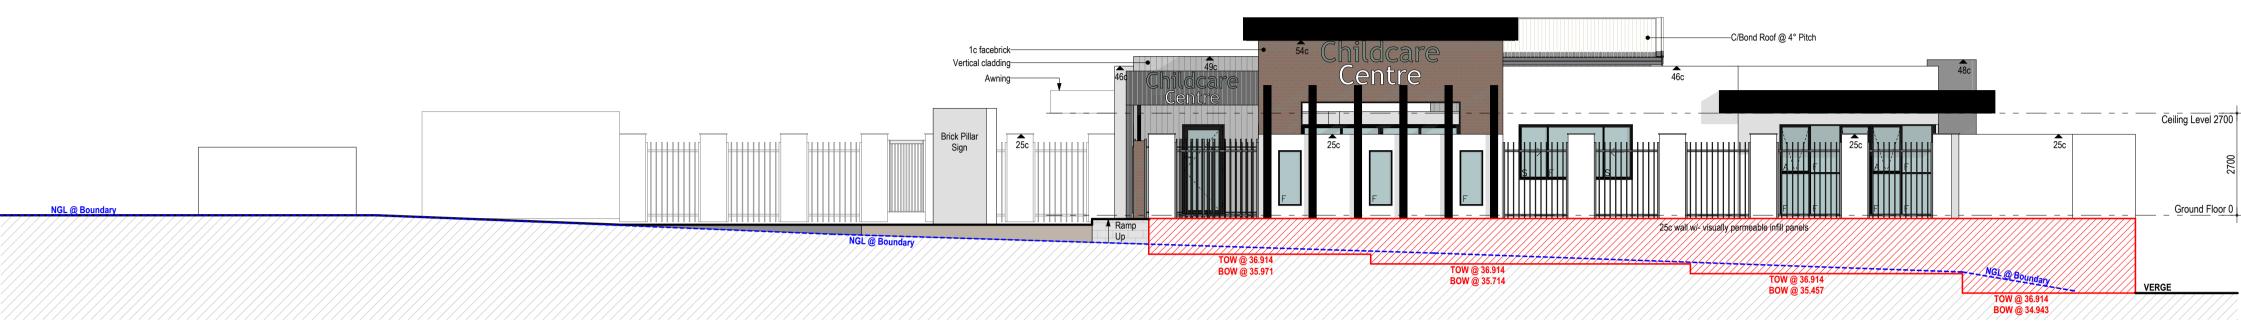


West Elevation 1

Scale 1:100

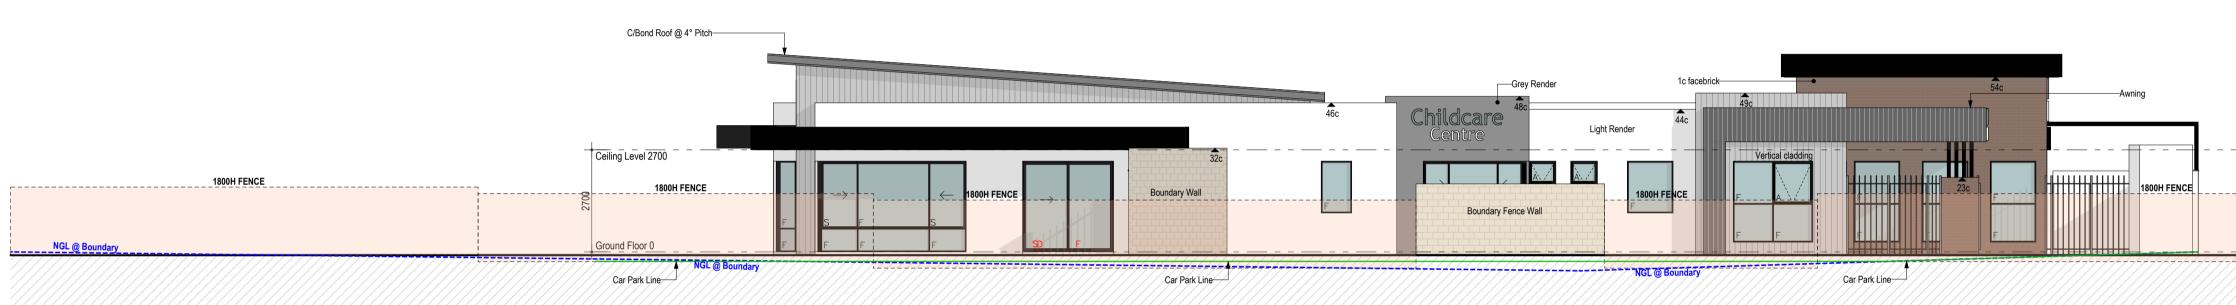

North Elevation 2

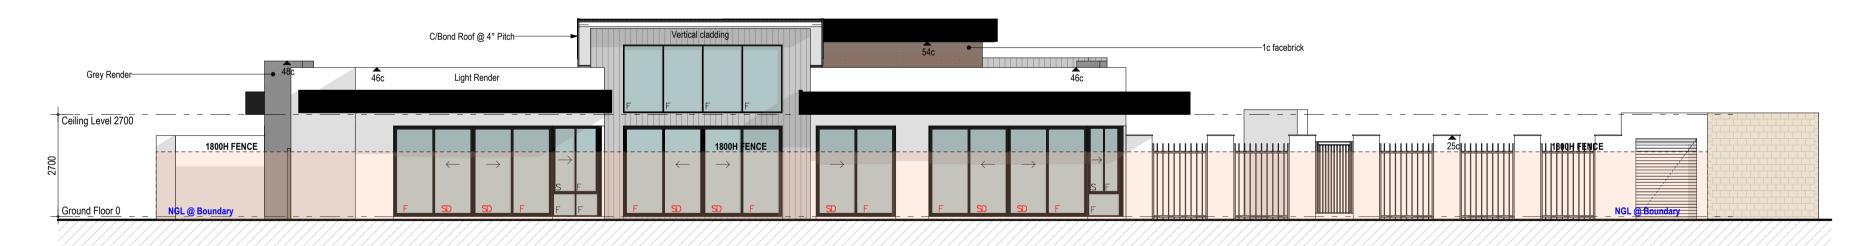

East Elevation 3

Scale 1:100




South Elevation 4

Scale 1:100

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MAC HOMES	Elevations					007	Planning Drawings	31.07.23						
	Licvations	Lievations			Development Approval			Sketch	29.07.22	GERMANO				
Project Name	Name Scale: as noted Sheet Size: Δ1		Rev:	Rev: Description: Drawn:		Drawn:	005	Sketch	24.02.22	DESIGNS				
Childcare Centre	55 175 155	/\ \ \ \ \ \ \ \ \ \ \ \ \ \ \ \ \ \ \	007	007 Planning Drawings		CD		Sketch	22.02.22					
Project Address	Project No:	Drawing No.:			,		003	Sketch	11.02.22			©COPYRIGHT		
Lot 1022 (#150) St Andrews Drive, YANCHEP	Andrews Drive, YANCHEP 21109 PD07 of 07		Revision Number:		Date:		002	002 Sketch		Unit: 3/1 Mulgui Road, Maiaga W.A 6090 This plan shall remain the sole		This plan shall remain the sole property of		
Lot 1012 (1/100) ot / tildiowo bilvo, 1/1101121	1	. 20. 0. 0.	007		31.07.2023			Concept Design	10.01.22	(08) 9248 8392	www.germanodesigns.com.au	GERMANO DESIGNS and must not be given, lent, resold or otherwise disposed or copied without		

Appendix 2

Transport Planning and Traffic Plans

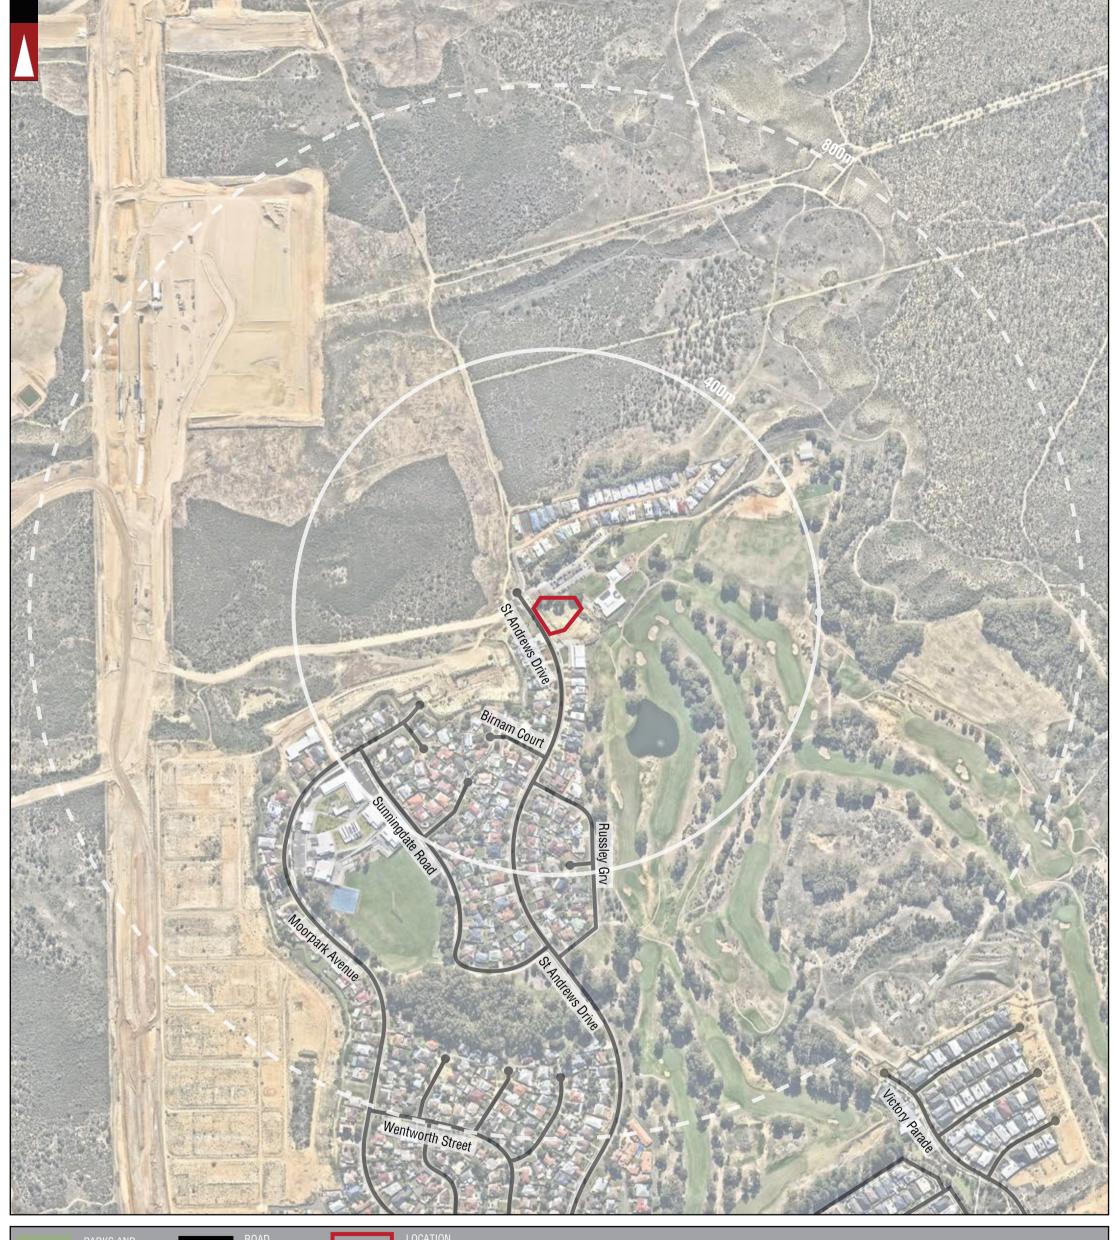





ROAD BRIDGE

CITY OF PERTH

LOCATION BOUNDARY DISTANCE FROM LOCATION LOCAL GOVERNMENT NAME

LOCAL AUTHORITY BOUNDARY

В	01-08-2023	INFORMATION UPDATED
Α	21-07-2022	ISSUED FOR REVIEW
No	DATE	AMENDMENT

PROJECT: LOT 1022 (NO 150) ST ANDREWS DRIVE, YANCHEP	DRAWN BY:
TITLE: LOCALITY PLAN - 800M RADIUS	10
DRAWING NUMBER: KC01437.000_S01	0.5.


LEGEND

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21-07-2022

DATE

ISSUED FOR REVIEW

AMENDMENT

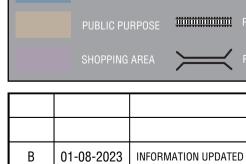Α

No

CITY OF PERTH

DISTANCE FROM LOCATION LOCAL GOVERNMENT NAME

LOCAL AUTHORITY BOUNDARY

Given there are no existing Public Transport routes within 800m radius from the subjec development site, above is shown the inset from the Transport map which indicates the closest public transport routes in the surrounding.

LEGEND

PROJECT: LOT 1022 (NO 150) ST ANDREWS DRIVE, YANCHEP	DRAWN BY:
PUBLIC TRANSPORT PLAN - 800M RADIUS	J.S.
DRAWING NUMBER: KC01437.000_S03	J.S.

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В

Α

No

DATE

ROAD
Hay Street STREET NAME
RAILWAY

ROAD BRIDGE

CITY OF PERTH

LOCATION BOUNDARY DISTANCE FROM LOCATION LOCAL GOVERNMENT NAME

LOCAL AUTHORITY BOUNDARY PEDESTRIAN PATH

01-08-2023 INFORMATION UPDATED
21-07-2022 ISSUED FOR REVIEW

AMENDMENT

PROJECT:
LOT 1022 (NO 150) ST ANDREWS DRIVE, YANCHEP


TITLE:
PEDESTRIAN PATHS PLAN - 800M RADIUS


DRAWING NUMBER:
KC01437.000_S04

LEGEND

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KCTT (Trading as KC Traffic and Transport Pty Ltd)
PO Box 1456 Scarborough WA 6922



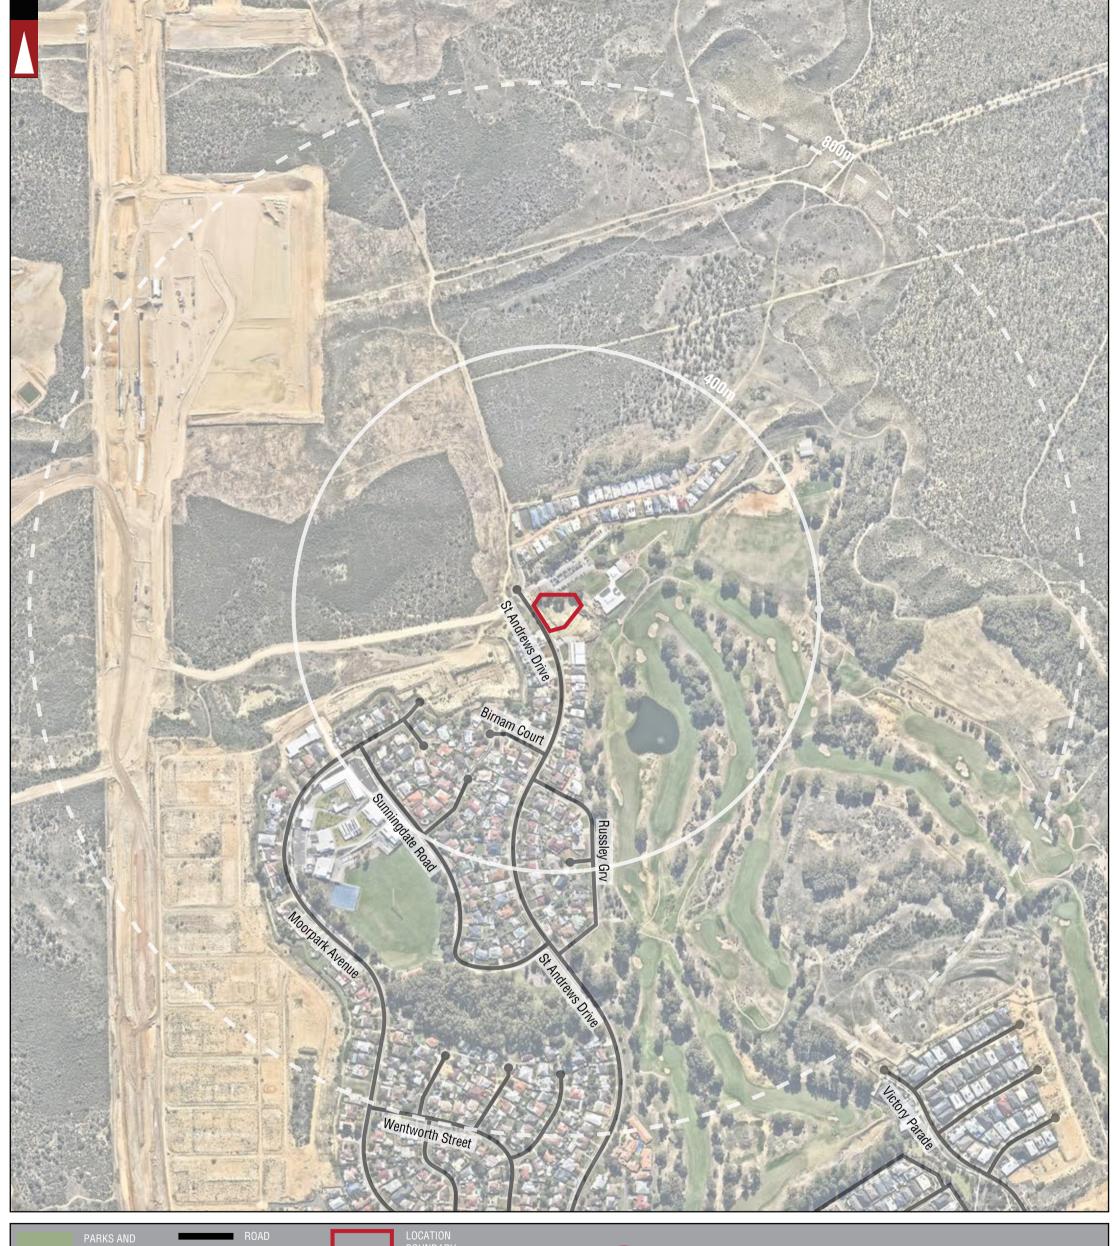

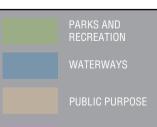

В

No

DATE

Hay Street STREET NAME

ROAD BRIDGE

CITY OF PERTH

LOCATION BOUNDARY DISTANCE FROM LOCATION LOCAL GOVERNMENT NAME

LOCAL AUTHORITY BOUNDARY

5,512

AM 1145 – 381 PM 1630 – 480

EAST OF HARLOW ROAD

2014

NUMBER OF VEHICLES PER AM PEAK HOUR NUMBER OF VEHICLES PER PM PEAK HOUR

No traffic data available within analised area

01-08-2023 INFORMATION UPDATED 21-07-2022 ISSUED FOR REVIEW

AMENDMENT

PROJECT: LOT 1022 (NO 150) ST ANDREWS DRIVE, YANCHEP

EXISTING TRAFFIC COUNTS - 800M RADIUS

KC01437.000_S05


DRAWN BY:

J.S.

Civil & Traffic Engineering Consultants KCTT (Trading as KC Traffic and Transport Pty Ltd) PO Box 1456 Scarborough WA 6922

LEGEND



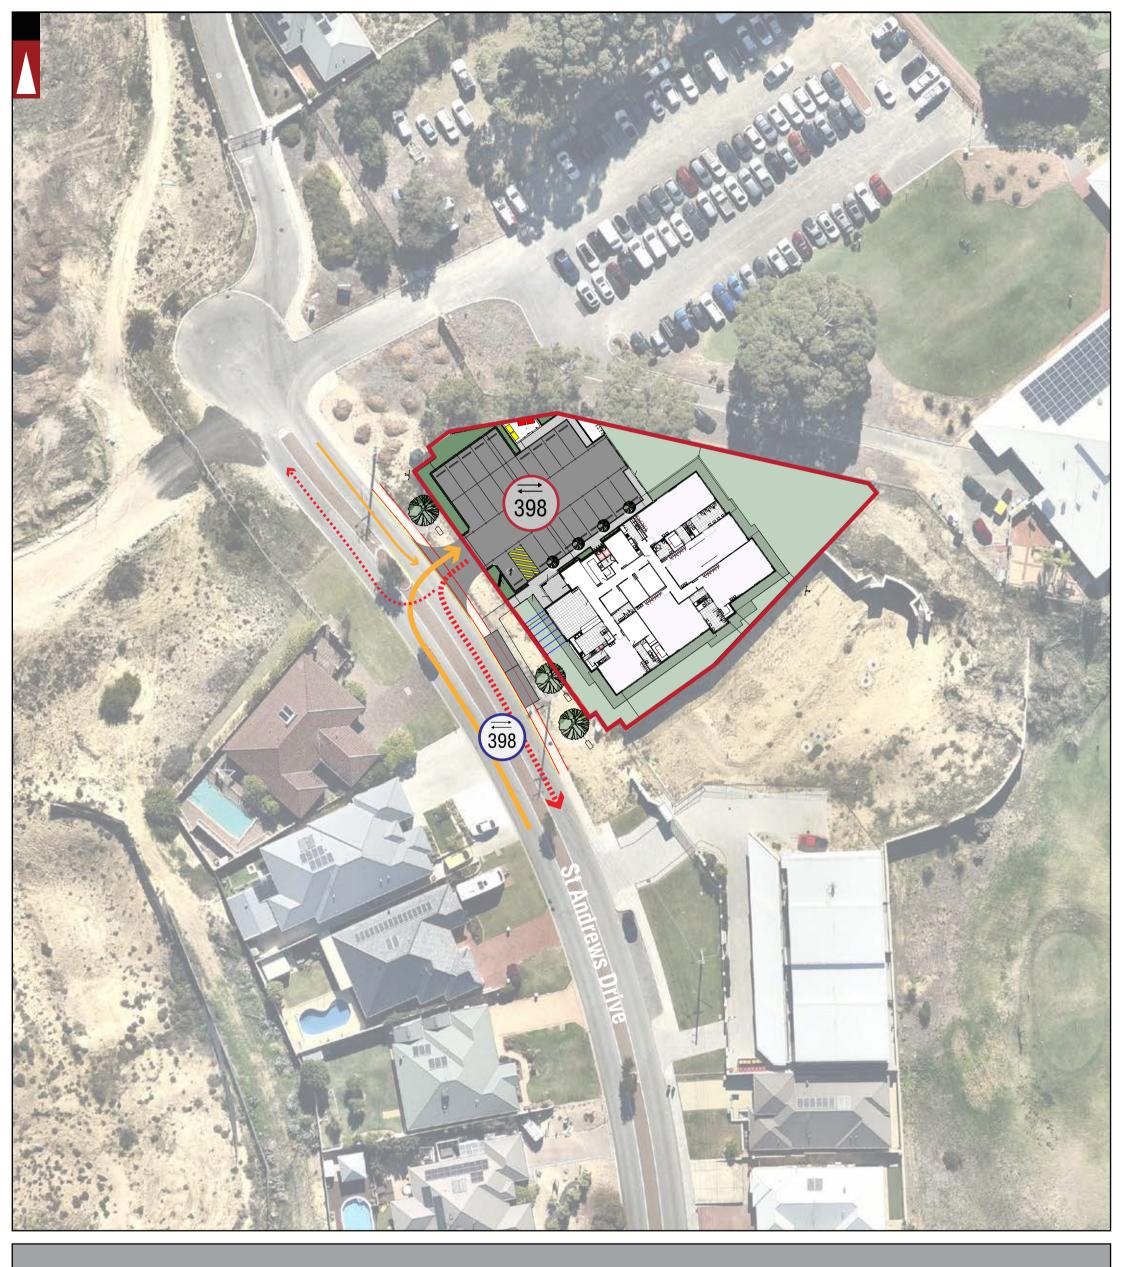



LOCATION BOUNDARY



Total Expected Traffic Generation from the proposed development





Total Expected Traffic Generation from Subject Site on the specific section of road - IN and OUT direction




LEGEND

			PROJECT: LOT 1022 (NO 150) ST ANDREWS DRIVE, YANCHEP	DRAWN
			LOT 1022 (NO 130) ST ANDREWS DRIVE, TANGER	BY:
			TITLE:	
В	01-08-2023	PROPOSED LAYOUT AMENDED	TRAFFIC FLOW DIAGRAM - DAILY	
۸	22-07-2022	ISSUED FOR REVIEW	TIVILLIO LEGAL BINGLOUIN BAILET	J.S.
A	22-01-2022	1920ED FOR KENIEM	DRAWING NUMBER:	
No	DATE	AMENDMENT	KC01437 000 S06	

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LOCATION BOUNDARY 1,389

Total Expected Traffic Generation from the proposed development

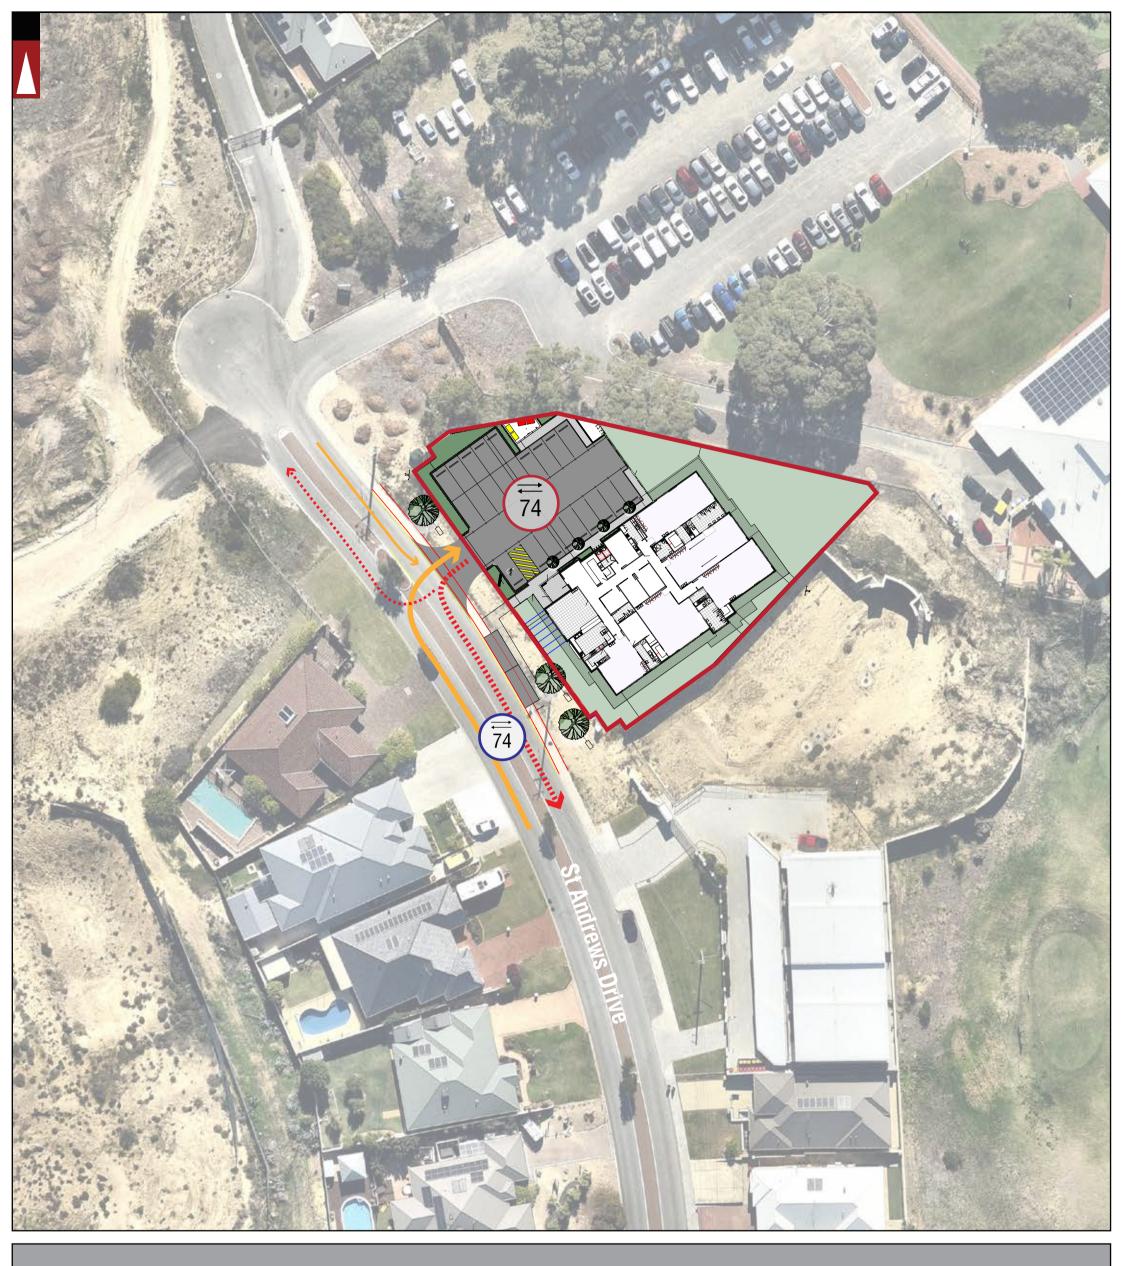Traffic Flow IN Direction

Lewis Road R

ROAD NAME

503

Total Expected Traffic Generation from Subject Site on the specific section of road - IN and OUT direction

.....


Traffic Flow OUT Direction

LEGEND

			PROJECT: LOT 1022 (NO 150) ST ANDREWS DRIVE, YANCHEP	DRAWN BY:
В	01-08-2023	PROPOSED LAYOUT AMENDED	TITLE: TRAFFIC FLOW DIAGRAM - AM PEAK DRAWING NUMBER: KC01437.000_ S07	- J.S.
Α	22-07-2022	ISSUED FOR REVIEW		
No	DATE	AMENDMENT		

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LOCATION BOUNDARY

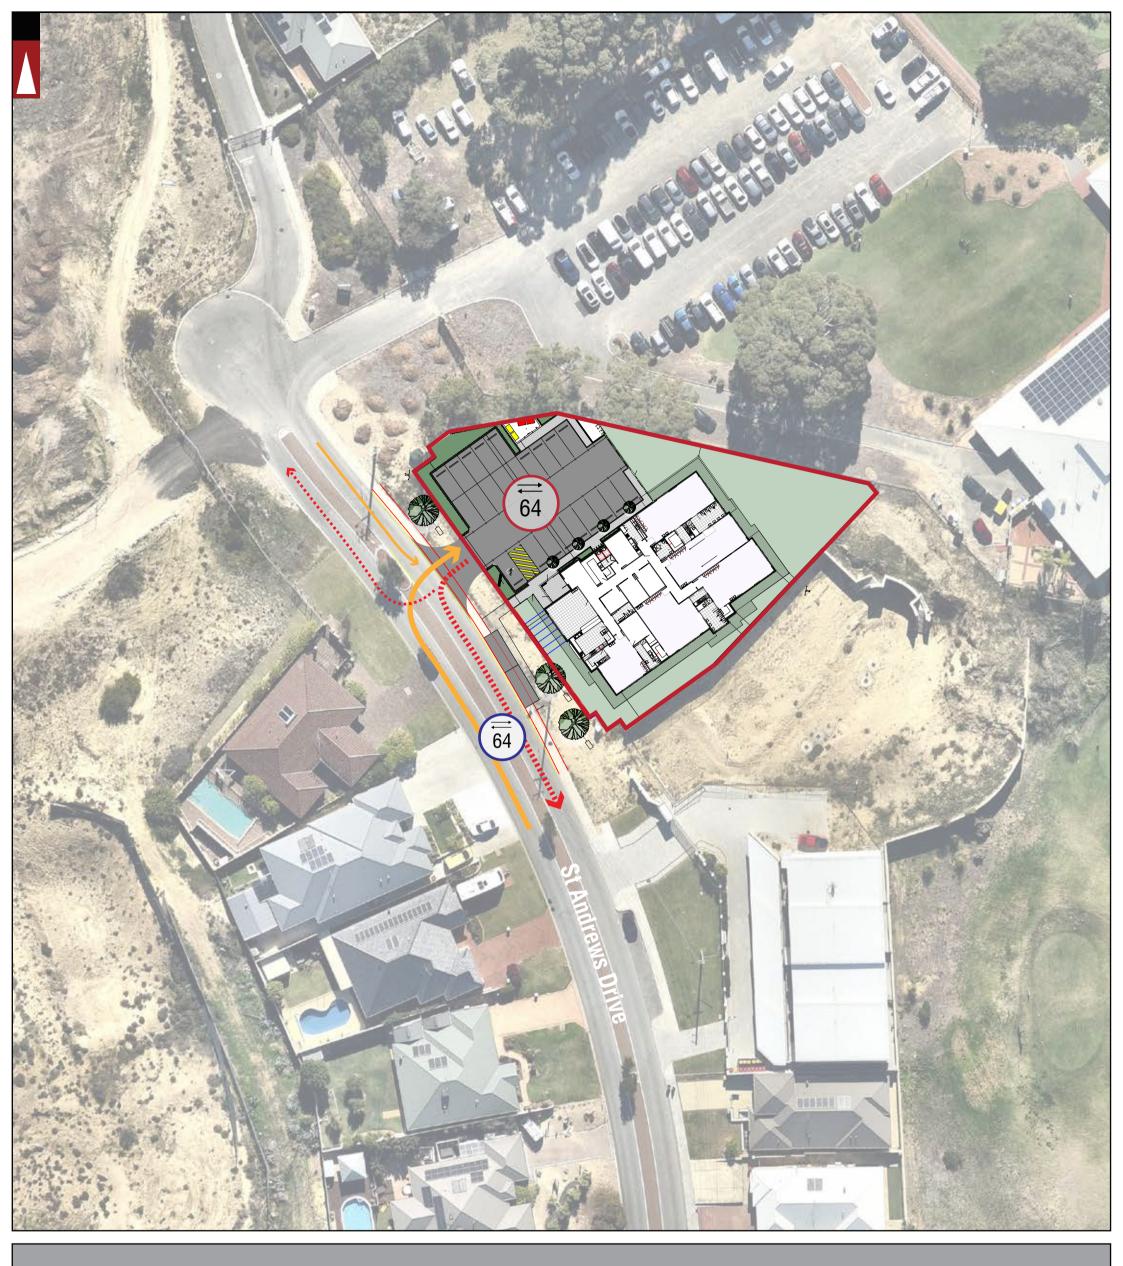

Total Expected Traffic Generation from the proposed development





Total Expected Traffic Generation from Subject Site on the specific section of road - IN and OUT direction

LEGEND

			PROJECT: LOT 1022 (NO 150) ST ANDREWS DRIVE, YANCHEP	DRAWN BY:
В	01-08-2023	PROPOSED LAYOUT AMENDED	TRAFFIC FLOW DIAGRAM - PM PEAK	
Α	22-07-2022	ISSUED FOR REVIEW	DRAWING NUMBER:	J.S.
No	DATE	AMENDMENT	KC01437.000_S08	

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Appendix 3

Vehicle Turning Circle Plan

