


PROPOSED McDONALDS RESTAURANT LOT 703 LISFORD AVE, TWO ROCKS WA OBTRUSIVE LIGHT ANALYSIS

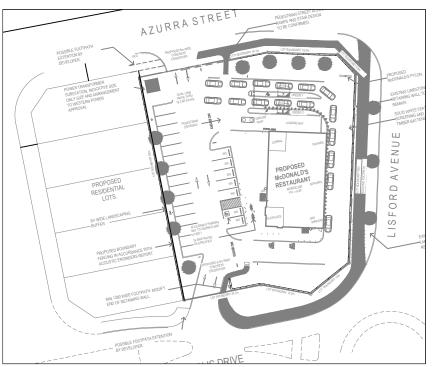

SITE PLAN
SCALE: N.T.S.

GENERAL LIGHTING NOTES:

- 1. THIS DRAWING SET DEMONSTRATES COMPLIANCE WITH AS/NZS4282:2023 FOR THE PROPOSED LIGHTING ARRANGEMENT SHOWN, INCLUDING ILLUMINATED SIGN LUMINANCE LIMITS.
- 2. THE CARPARK AND PUBLIC SPACES COMPLIES WITH AS1158.3.1:2020 CAT PC1, PCD AND PCX.
- 3. ALL LUMINAIRE DATA IS SUPPLIED BY MANUFACTURER.
- 4. DESIGN SOFTWARE USE AGI32 V20.
- 5. ALL CALCULATIONS AND RESULTS PROVIDED ARE SUBJECT TO TOLERANCES IN ACCORDANCE WITH AS/NZS3827.1-1998 AND AS.NZS3827.2-1998 LIGHTING SYSTEM PERFORMANCE AND ACCURACY TOLERANCES.

OBTRUSIVE LIGHTING ANALYSIS:

- 6. COMPLIANCE WITH AS/NZS4282-2019 IS DEMONSTRATED FOR AN A4 ENVIRONMENTAL ZONE FOR NON-CURFEW AND CURFEW OPERATION (i.e. 24 HRS)
- 7. THE PLAYPLACE AND McCAFE SIGNS NOTED ON SHEET 3 OF THIS DRAWING SET ARE TO BE DIMMED TO 30% OUTPUT DURING CURFEW HOURS.
- 8. ALL ILLUMINATED SIGNAGE TO BE LIMITED TO 350cd/m² BY THE SIGN MANUFACTURER.
- 9. ALL OBTRUSIVE LIGHT ANALYSIS IS EVALUATED AT INITIAL FLUX.

Drawing List							
Drawing Number	Sheet Number	Revision	Title				
HA01684-E01	1	Α	Title Page				
HA01684-E01	2	Α	Luminaire Layout				
HA01684-E01	3	Α	Obtrusive Light Analysis				
HA01684-E01	4	Α	Sign Luminance Calculations				

LIGHTING CERTIFICATION

* PUBLIC AREA LIGHTING COMPLIES WITH
AS/NZS1158.3.1:2020 PC1, PCD, PCX.

* PLAYPLACE & McCAFE SIGNS SHOWN ON SHEET 3 TO

LIGHTING CERTIFIED TO COMPLY WITH AS/NZS4282:2019 FOR NON-CURFEW AND CURFEW OPERATION IN AN A4 ENVIRONMENTAL

BE DIMMED TO 30% OUTPUT DURING CURFEW.

* ALL LUMINAIRE DATA HAS BEEN SUPPLIED BY

McDONALDS TWO ROCKS WA



LOCALITY PLAN

SCALE: N.T.S.

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PROPOSED McDONALDS RESTAURANT LOT 703 LISFORD AVE TOW ROCKS WA ELECTRICAL SERVICES
LIGHTING
TITLE PAGE

 Drawn:
 SAF
 Chk
 SAF
 Date:
 25/03/2024

 Scale:
 Drawing No.
 Rev
 Size


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 A3

Rubidium Light

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Loganhome QLD 4129
E admin@nubidiumlight.com.au

MIES No. 280



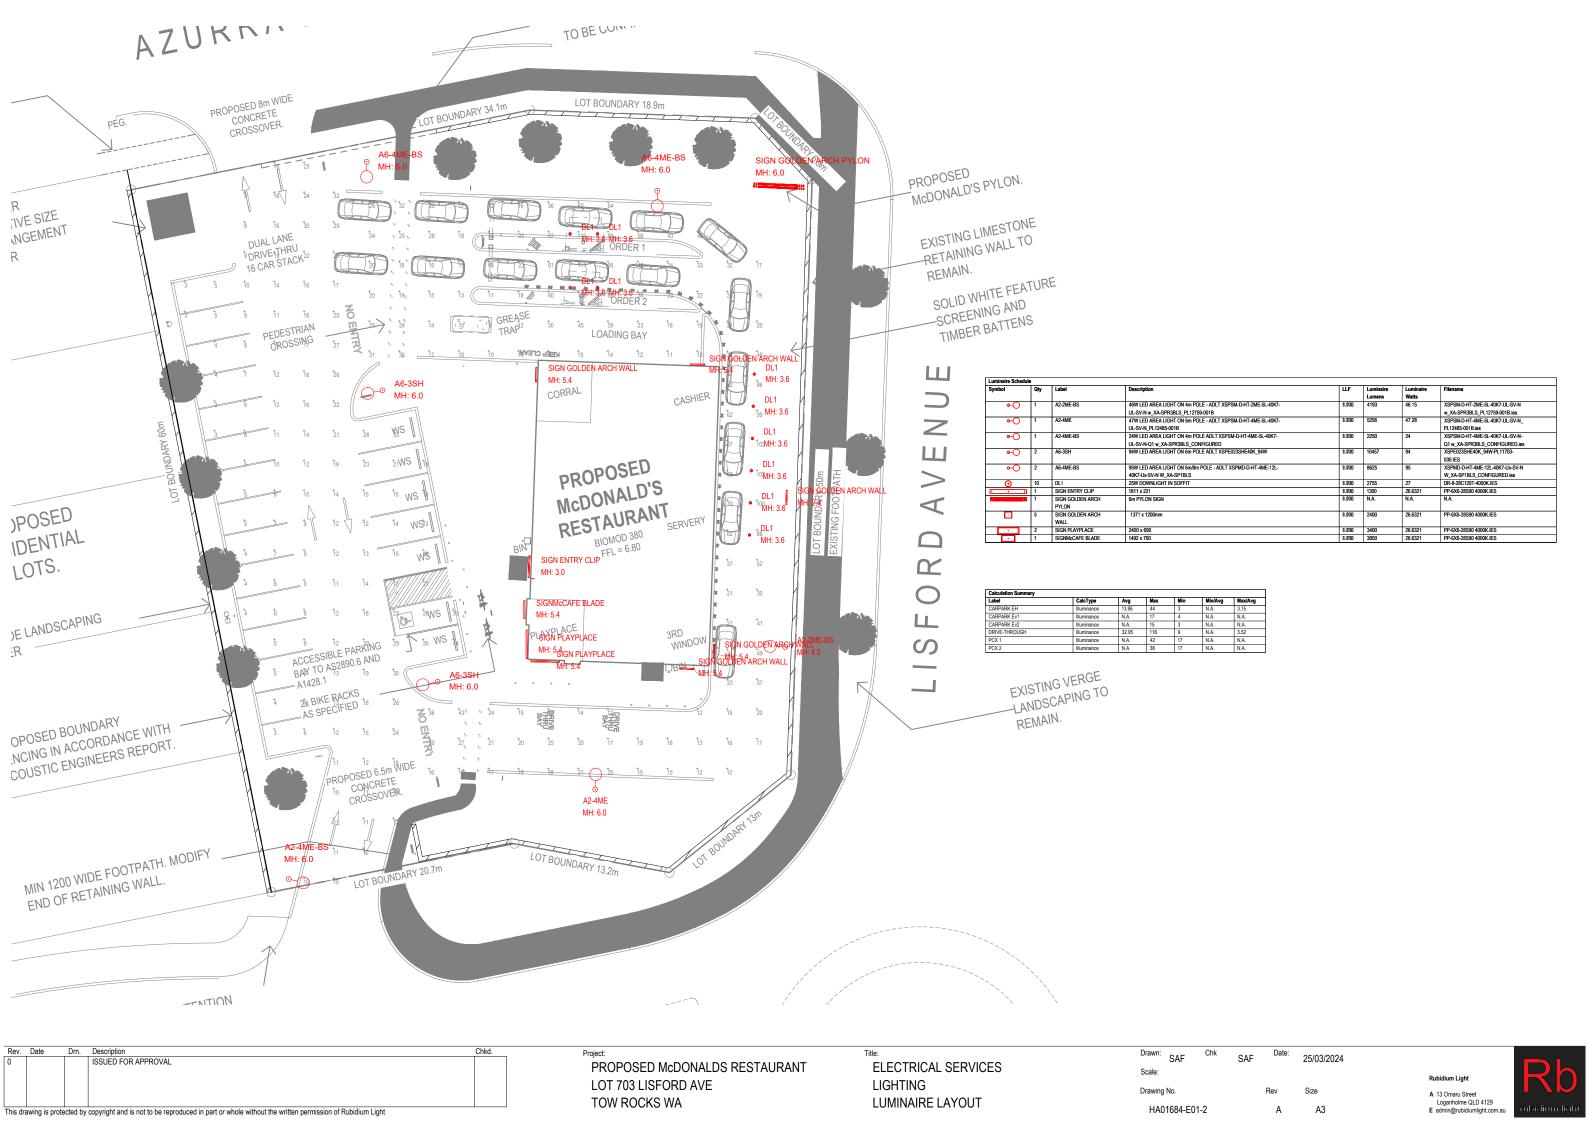



FILENAME: HA01684 - 1 CURFEW DIMMED 25/03/2024 2:18:43 PM

ILLUMINANCE MAXIMUM ALLOWABLE VALUE: 5 LUX

CALCULATIONS TESTED (9):

ONECCE (TICITO TECTED (5).		
	TEST	MAX.
CALCULATION LABEL	RESULT	S
ILLUM.		
REL BDY PROPOSED RESIDENTIAL_ILL_SEG1	PASS	5
REL BDY LISFORD AVE_ILL_SEG1	PASS	0
REL BDY LISFORD AVE_ILL_SEG2	PASS	0
REL BDY LISFORD AVE_ILL_SEG3	PASS	0
REL BDY LISFORD AVE_ILL_SEG4	PASS	0
REL BDY LISFORD AVE_ILL_SEG5	PASS	0
REL BDY LISFORD AVE_ILL_SEG6	PASS	0
REL BDY AZURRA STREET_ILL_SEG1	PASS	1
REL BDY AZURRA STREET_ILL_SEG2	PASS	3

LUMINOUS INTENSITY (CD) AT VERTICAL PLANESMAXIMUM ALLOWABLE VALUE: 2500 CD

CALCULATIONS TESTED (9):

	TEST	
CALCULATION LABEL	RESULTS	
REL BDY PROPOSED RESIDENTIAL_CD_SEG1	PASS	
REL BDY LISFORD AVE_CD_SEG1	PASS	
REL BDY LISFORD AVE_CD_SEG2	PASS	
REL BDY LISFORD AVE_CD_SEG3	PASS	
REL BDY LISFORD AVE_CD_SEG4	PASS	
REL BDY LISFORD AVE_CD_SEG5	PASS	
REL BDY LISFORD AVE_CD_SEG6	PASS	
REL BDY AZURRA STREET_CD_SEG1	PASS	
REL BDY AZURRA STREET_CD_SEG2	PASS	

Upward Waste Light Ratio (UWLR) Maximum Allowable Value: 3.0 %

Calculated UWLR: 11.6 % (INCLUDING SIGNS)

PASS Test Results:


Rev.	Date	Drn.	Description	Chkd.	
0			ISSUED FOR APPROVAL		
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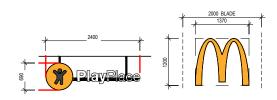
PROPOSED McDONALDS RESTAURANT LOT 703 LISFORD AVE TOW ROCKS WA

ELECTRICAL SERVICES LIGHTING **OBTRUSIVE LIGHT ANALYSIS**

Drawn: SAF	Chk	SAF	Date:	25/03/2024	
Scale:					
Drawing No.			Rev	Size	
HA01684-E0)1-3		Α	A3	

A 13 Omaru Street Loganholme QLD 4129 E admin@rubidiumlight.com



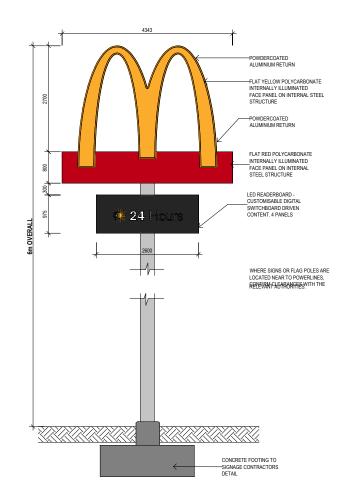







McDonalds Two Rocks - Sign Luminance Calculations

	ILLUMINATED AREA	INSTALLED MODULES	LUMENS	COLOUR	SIGN Tx FACTOR	EXITANCE (LUMENS PER SQ.M)	L (diffuse) EXITANCE/PI LIMIT 2500
PYLON SIGN ARCH	6.784	696	34800	YELLOW	0.7	5130	1144
PYLON SIGN RED KEYST ONE	6.954	518	25900	RED	0.5	3724	593
WALL ARCH	0.5	48	3600	YELLOW	0.7	7200	1605
PLAYPLACE	3.111	112	8400	WHITE/	0.7	2700	602
T E (II E / OE	0.111	112	0.00	YELLOW	0.1	2100	002
ENTRY CLIP	0.3978	130	812.5	RED	0.5	2042	325
Mc CAFE BLADE	1.0444	77	5775	WHITE/	0.7	5529	1233
WIGOV E DEPOE	1.5444		0770	BLACK	0.1	0029	1200
BUTTON	1.1304	68	5100	WHITE/	0.7	4512	1006
BOTTON	1.1004	0	0 100	BLACK	0.1	7012	1000

TABLE 3.3 MAXIMUM LUMINOUS INTENSITIES PER LUMINAIRE

Zone	Luminous intensity (I), cd							
Zone	Non-curfew L1	Non-curfew L2	Curfew					
A0 0	See Note	See Note	0					
& Alov S	2 500	5 000	500					
02 A2 3	7 500	12 500	1 000					
S 5A35	12 500	25 000	2 500					
A4	25 000	50 000	2 500					
S STV	100 000	150 000	0					

NOTE: For A0, I shall be as close to zero as practicable without impacting safety Considerations.

